

TOWN OF WELLESLEY



MASSACHUSETTS

ZONING BOARD OF APPEALS
888 WORCESTER STREET • SUITE 160 • WELLESLEY, MA 02482

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WALTER B. ADAMS
DEREK B. REDGATE
PETER COVIO

ZBA 2024-80

Petition of Amos Ami Saada
679 Worcester Street (ABLS)

Pursuant to due notice, the Special Permit Granting Authority held a Remote Public Hearing on Thursday, December 5, 2024 at 7:30 pm, on the petition of Amos Ami Saada requesting a Special Permit pursuant to the provisions of Section 2.1.A.8.b and Section 6.3 of the Zoning Bylaw for an Educational Use, namely Applied Behavioral Learning Services (ABLS), in a portion of an existing two-family dwelling at 679 Worcester Street, which is a use not allowed by right in a 20,000 square foot Single Residence District.

On November 4, 2024, the petitioner filed a request for a hearing before this Authority, and thereafter, due notice of the hearing was given by mailing and publication.

Present at the public hearing were David Himmelberger, Esq. and Mariela Vargas-Irwin.

Mr. Himmelberger said that the matter was initially filed by Ms. Vargas-Irwin for a special permit for other than non-profit educational purposes, namely services to provide children with special needs, that are allowed by special permit in a single residence district. He said that after his review of Ms. Vargas-Irwin's proposal, he became convinced that this is an as of right use for child care facilities under Section 2.1.A.3A of the Zoning Bylaw (ZBL), with the exception of the two or three students who are 16 years or older. He discussed the ZBL and Massachusetts General Law (MGL) definitions of Child Care Facility. He said that the scope of the requested relief pertains to a special permit for up to five students who are 16 years or older to receive services at the facility. He said that the Applicant chose to pursue the matter as a special permit rather than under the Dover Amendment. He said that the proposed use will comply with Section 6.3.D. Special Use Permit Standards of the ZBL.

A Board member asked about the number of staff and students. Ms. Vargas-Irwin said that not everyone will be on site at the same time. She said that there may be four students in the morning and six in the afternoon. She said that 15 staff members is ideal but hard to achieve. She said that some of the staff members also serve some facilities in their own homes. She said that ABLS does not provide transportation.

Property Address: 679 Worcester St., Wellesley, MA
Deed Certificate #212984

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A Board member discussed concerns about egress and separation of the living and ABLS spaces. He said that the Board will need to see a fully vetted set of plans that identify separations between the three functions of the building and how they interface. He suggested that the Applicant speak with the Building Inspector regarding Building Code implications.

The Board voted unanimously to continue the matter to January 9, 2025.

January 9, 2025

Mr. Himmelberger said that while going through the process to develop plans that delineate the ~~internal~~ uses within the building, namely, the two dwelling units and the space for Ms. Vargas-Irwin's child care and educational program, Ms. Vargas-Irwin decided that it would make sense to build an addition on the first floor at the rear of the building. He said that no relief is required for the proposed conforming addition. He said the request is for a special permit under the provisions of the ZBL for an educational use in a Single Family District to offer services to students who are 16 years of age and older.

Mr. Himmelberger said that he spoke with Michael Grant, Building Inspector, about the program qualifying as a child care facility. He said that Mr. Grant will enforce the bylaw with regard to the enumerated conditions that are required for the operation of any child care facility, which is what Ms. Vargas-Irwin will be providing to students who are less than 16 years of age. He said that the Building Inspector has jurisdiction over parking circulation around the building with respect to operation of the child care facility. He said that a plot plan was submitted that shows the design of the parking spaces and drop off area.

The Chairman discussed MGL Chapter 15, Section 6. He said that his understanding is that the State does not deal with the students who are over 16 years of age. Ms. Vargas-Irwin said that in many ways, the students who are over 16 years old fall under the same definition as younger children because they have special needs. She said that they come to the center because they can't live independently. She said that the reason that the regulations are the same, even though the students might be 18 years old, is that they are not competent. She said that the Autism Commission, the Insurance Commission and Mass Health all see them as equivalent, regardless of age. She said that the parents have custody of them. She said that early childhood and care is not regulated because none of her students sleep at the center.

The Chairman questioned whether the proposed use could be done as of right under Section 2.1.A.3A of the Zoning Bylaw. Mr. Himmelberger said that his understanding is that child care facility only applies to children up to the age of 16 if they have special needs but individuals 16 years or older with special needs don't fall within the State's definition of child care facility, which is what the Town uses as the basis for Section 2.1.3A of the ZBL. He said that he believes that a special permit under Section 2.1.A.8,b of the ZBL is needed for those special needs students who are 16 years and older, not Section 2.1.A.3A.

The Chairman asked about permitting from the State for the facility that Ms. Vargas-Irwin currently operates at 110 Cedar Street in Wellesley. Ms. Vargas-Irwin said that her two students who are over 16 years of age are funded by insurance. She said that there is some regulation by the Autism Commission but the insurance company has jurisdiction.

2025 JAN 23 PM

ZBA 2024-80

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Mr. Himmelberger discussed the revised plans. He said that the plans show how the interior spaces are segregated. He said that Plan A-6 shows the proposed first floor, which includes the single story addition to the right rear and also shows a ramp at the front right. He said that the parking plan shows two ADA parking spaces adjacent to the ramp, which is one more than required. He said that the second floor will remain as is. He said that the layout is further delineated in color segments on Plan A-8. He said that the white areas are the ABLS Facility, with basement space as well as space on the right side of the first floor. He said that the green and yellow areas on the first and second floors are residential areas that have nothing to do with the use permit that is being sought. He said that the Section 2.1.A.8.b use is confined to the white areas shown on Plan A-8.

Ms. Vargas-Irwin said that the proposed white space on the first floor consists of a waiting room where students or parents come in, her office, and a designated classroom with three bathrooms for the younger students. She said that older students will be in the white portion of the basement. She said that the green portion of the basement will remain unfinished. She said that she will live in the green area with her senior in Wellesley High and her freshman in college who will come home on break occasionally. She said that the smaller apartment is currently rented and she plans to keep the tenant at least through construction. She said that once the center moves to 679 Worcester Street, they will decide whether to keep the tenant.

A Board member asked about the pinch point off Worcester Street that is shown on Plan A-4. He asked if 18 feet at its narrowest is enough to let two cars through. Mr. Himmelberger said that according to the design standards for off-street parking in Section 5.17 of the ZBL, the minimum width for two-way use is 18 feet. He said that they have 25 feet at the mouth onto Route 9 but 18 feet as you come in. He said that a benefit of its location is that there is a traffic light that stops traffic going west at the turnaround every minute or so. He said that there are always breaks in the traffic.

A Board member asked if the building is regulated by the Historic Commission. Mr. Himmelberger said that it is an eligible building because it is pre-1949 but because less than 50 percent of its exterior elevations will be covered up or removed, it doesn't qualify as a demolition and is therefore not subject to further demolition review by the Historic Commission.

No member of the public wished to speak to the petition.

Statement of Facts

The Petitioner is requesting a Special Permit pursuant to the provisions of Section 2.1.A.8.b and Section 6.3 of the Zoning Bylaw for an Educational Use, namely, Applied Behavioral Learning Services (ABLS), in a portion of an existing two-family dwelling, which is a use not allowed by right in a 20,000 square foot Single Residence District.

The subject premises is located at 679 Worcester Street, on a 36,598 square foot lot. The property contains a main house and a one-story detached garage. ABLS offers full-time, extensive behavior analytic intervention and specialized weekly sessions focusing on social skills development for members of the Autism community. Group sessions typically last two to three hours, with most students being dropped off. The Center would host ABLS Theatrical, a nonprofit organization led by Wellesley High School students to provide inclusive, affordable community theater.

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**Petition of Amos Ami Saada
679 Worcester Street (ABLS)**

Letter to Zoning Board of Appeals, dated 11/26/24, from David Himmelberger, Esq., Letter to Zoning Board of Appeals, dated 1/2/25, from David Himmelberger, Esq., Letter to Zoning Board of Appeals from Mariela Vargas-Irwin, Aerial Photograph, Parking Layout, Floor Plans, prepared by Cubicasa, Biography of Mariela Vargas-Irwin, Plot Plan, Floor Plans & Elevations Drawings, dated 1/2/25, revised 1/7/25, prepared by Emily's Interiors, were submitted.

On December 3, 2024, the Planning Board reviewed the petition and recommended that the Board delay action.

Decision

This Authority has made a careful study of the materials submitted and the information presented at the hearing.

The Petitioner is requesting a Special Permit to allow a portion of the existing two-family dwelling at 679 Worcester Street to be used as an Applied Behavioral Learning Services center in a Single Residence District.

It is the opinion of this Authority that the use of a portion of the property as an Applied Behavioral Learning Services center shall not disturb or disrupt the customary character of the residential neighborhood, and is in harmony with the intent and purpose of the Zoning Bylaw.

Therefore, a Special Permit is granted for the requested use, as voted unanimously by this Authority at the Public Hearing, in accordance with the submitted plans.

2025 JAN 23 PM 12:31

ZBA 2024-80

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APPEALS FROM THIS DECISION,
 IF ANY, SHALL BE MADE PURSUANT
 TO GENERAL LAWS, CHAPTER 40A,
 SECTION 17, AND SHALL BE FILED
 WITHIN 20 DAYS AFTER THE DATE
 OF FILING OF THIS DECISION IN THE
 OFFICE OF THE TOWN CLERK.

J. Randolph Becker (cm)
 J. Randolph Becker, Chairman

Walter B. Adams (cm)
 Walter B. Adams

Peter Covo (cm)
 Peter Covo

2025 JAN 23 PM 12:31

MA 02451
 WELLESLEY
 MASSACHUSETTS
 02451

ZBA 2024-80
 Applicant Amos Ami Saada
 Address 679 Worcester Street

NOT VALID FOR RECORDING UNTIL CERTIFIED BY TOWN CLERK


In accordance with Section 11 of Chapter 40A of the Massachusetts General Laws, I hereby certify that twenty (20) days have elapsed after the within decision was filed in the office of the Town Clerk for the Town of Wellesley, and that no appeal has been filed, or that if such appeal has been filed, that it has been dismissed or denied.

Date: February 3, 2025

Attest:

Cathryn J. Kato
 Cathryn Jane Kato
 Town Clerk

cc: Planning Board
 Inspector of Buildings
 lrm

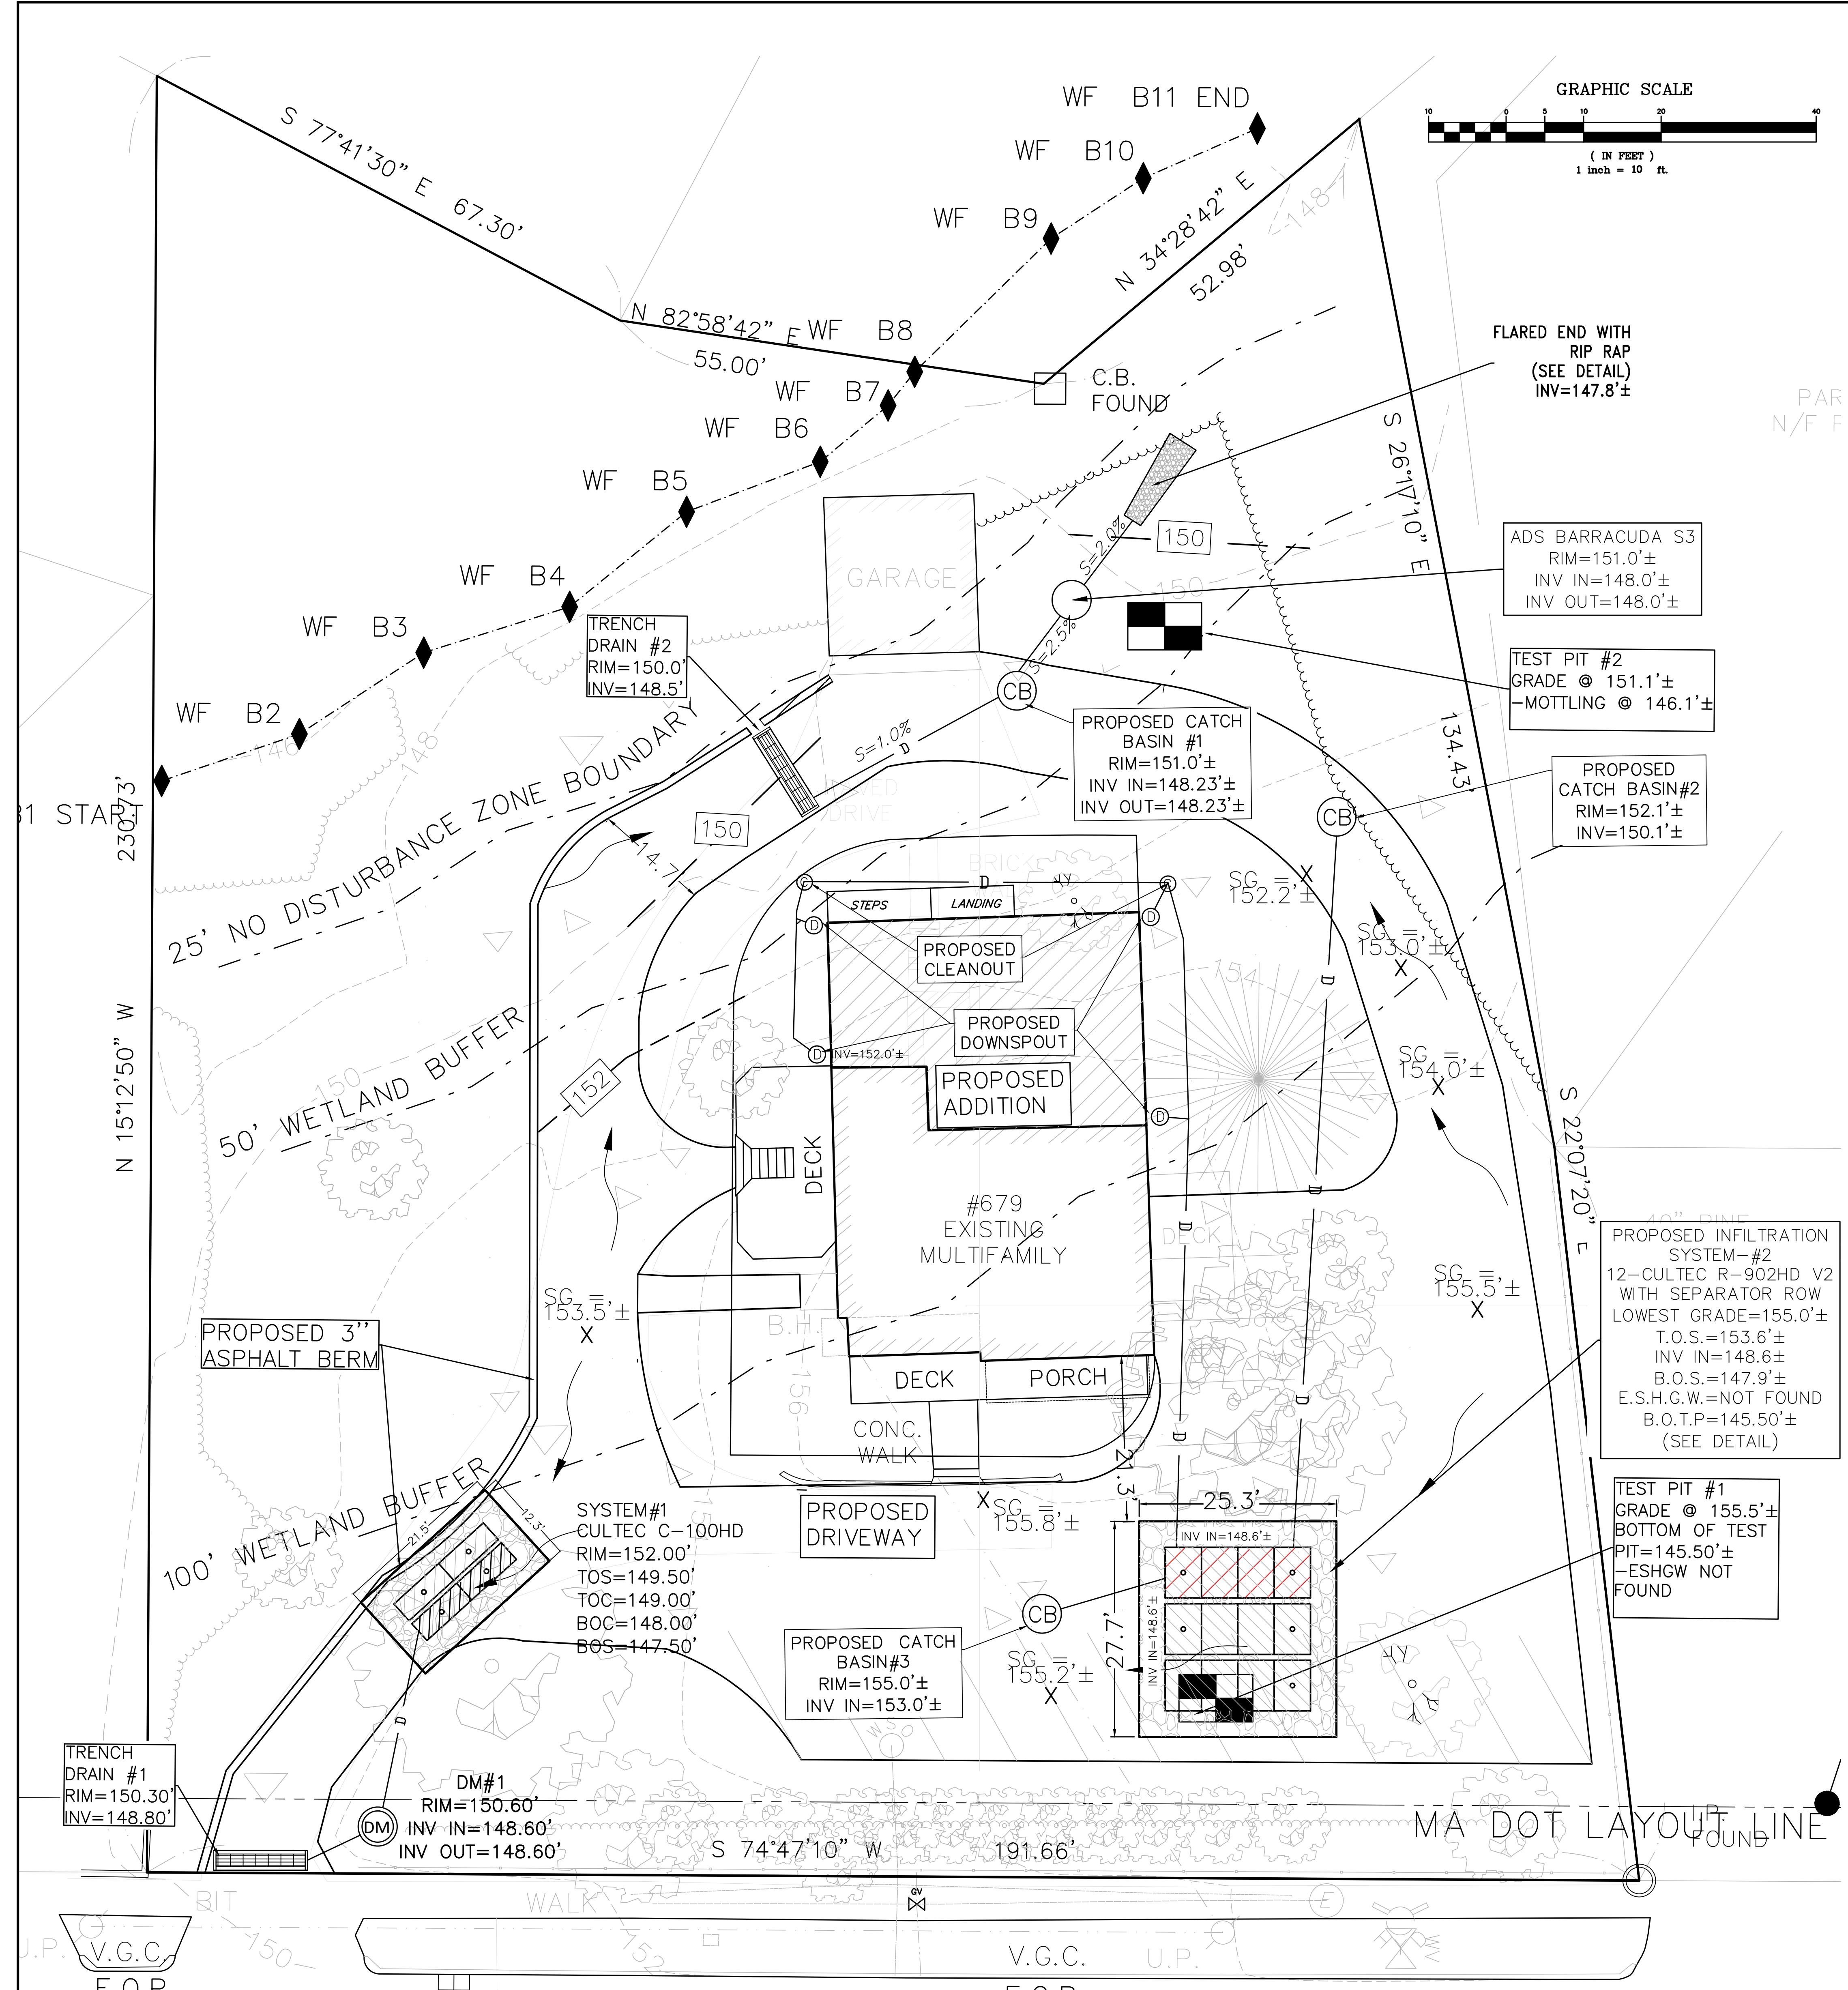

CONTRACTOR TO NOTIFY ENGINEER OF RECORD IF ANY GROUNDWATER IS FOUND DURING EXCAVATION/CONSTRUCTION.

ALL SURFACE WATER RUNOFF SHALL
BE DIRECTED AWAY FROM BUILDING
FOUNDATION AND AWAY FROM
NEIGHBORING PROPERTY

POWER BACKUP AND BACKFLOW
PREVENTER MUST BE INSTALLED
IN ALL SUMP PUMPS.

ALL SURFACE WATER RUNOFF SHALL BE DIRECTED AWAY FROM BUILDING FOUNDATION AND AWAY FROM NEIGHBORING PROPERTY.

BACKFLOW PREVENTERS MUST BE
INSTALLED IN ALL NEW BASEMENT
FIXTURES

EXISTING AND PROPOSED FOUNDATIONS ARE NOT UNDERMINED BY THE PROPOSED INFILTRATION SYSTEMS

RAIN FALL	RUNOFF RATE		VOLUME OF RUNOFF	
	EXISTING	PROPOSED	EXISTING	PROPOSED
2 year	0.16	0.02	1,058	29
10 year	1.06	0.33	3,674	1,6
25 year	1.81	0.76	5,815	2,84
50 year	2.43	1.13	7,570	3,89
100 year	3.52	1.55	10,702	5,09

EXCAVATION FOR THE INFILTRATION SYSTEM MUST BE
INSPECTED BY THE ENGINEER OF RECORD PRIOR TO
INSTALLATION. THE ENGINEER MUST BE NOTIFIED AT LEAST
72 HOURS IN ADVANCE TO SCHEDULE THIS INSPECTION.

EXISTING AREAS	
LOT AREA	36,589.1 S.F.
EXISTING IMPERVIOUS AREA	
BUILDING	1,401.0 S.F.
DRIVEWAY	3,502.0 S.F.
GARAGE	392.1 S.F.
COVER LANDING	22.4 S.F.
STEPS	71.6 S.F.
PORCH	104.0 S.F.
WALKWAY	89.6 S.F.
RETAINING WALL	19.3 S.F.
BULKHEAD	21.8 S.F.
DECK	374.3 S.F.
TOTAL	5,998.1 S.F.
TOTAL	S.F.
LANDSCAPE AREA	30,591.0 S.F.

TOTAL INCREASE IN IMPERVIOUS AREA = 7.

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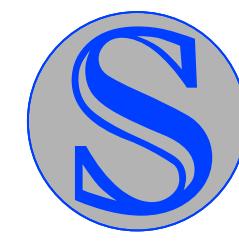
TEST PIT	#1	GROUND ELEVATION	155.5'
Depth (in)	Depth (ft)	Horizon/Layer	Texture
0.0-18.0	0.0-1.5	Ap	--
18.0-36.0	1.5-3.0	Bw	FINE SAND
36.0-90.0	3.0-7.5	C1	COARSE SAND
90.0-120.0	7.5-10.0	C2	FINE SAND

NOTES:

BOTTOM OF TEST PIT: 145.50 ft
ESHWG: NOT FOUND
PREFORMED BY: EDMOND SPRUHAN SE 14235

DEEP OBSERVATION HOLE NUMBER:			
TEST PIT	#2	GROUND ELEVATION	151.1' ±
Depth (in)	Depth (ft)	Horizon/Layer	Texture
0.0-12.0	0.0-1.0	Ap	--
12.0-24.0	1.0-2.0	Bw	--
24.0-96.0	3.0-7.5	C1	LOAMY SAND WITH COBBLES

NOTES:
BOTTOM OF TEST PIT: 143.1 ft
MOTTLING AT 146.1 FT
PREFORMED BY: EDMOND SPRUHAN SE 14235



SPRUHAN
ENGINEERING, P.C.

80 JEWETT ST, (SUITE 1)
NEWTON, MA 02458

Tel: 617-816-0722
Email:
edmond@spruhanenq.com

679 WORCESTER
STREET, WELLESLEY
MASSACHUSETTS


CIVIL PLAN

REVISION BLOCK

DATE:	9/24/2025
DRAWN BY:	Y.L.
CHECKED BY:	G.B.
APPROVED BY:	E.S

CIVIL PLAN


SHEET C1.0

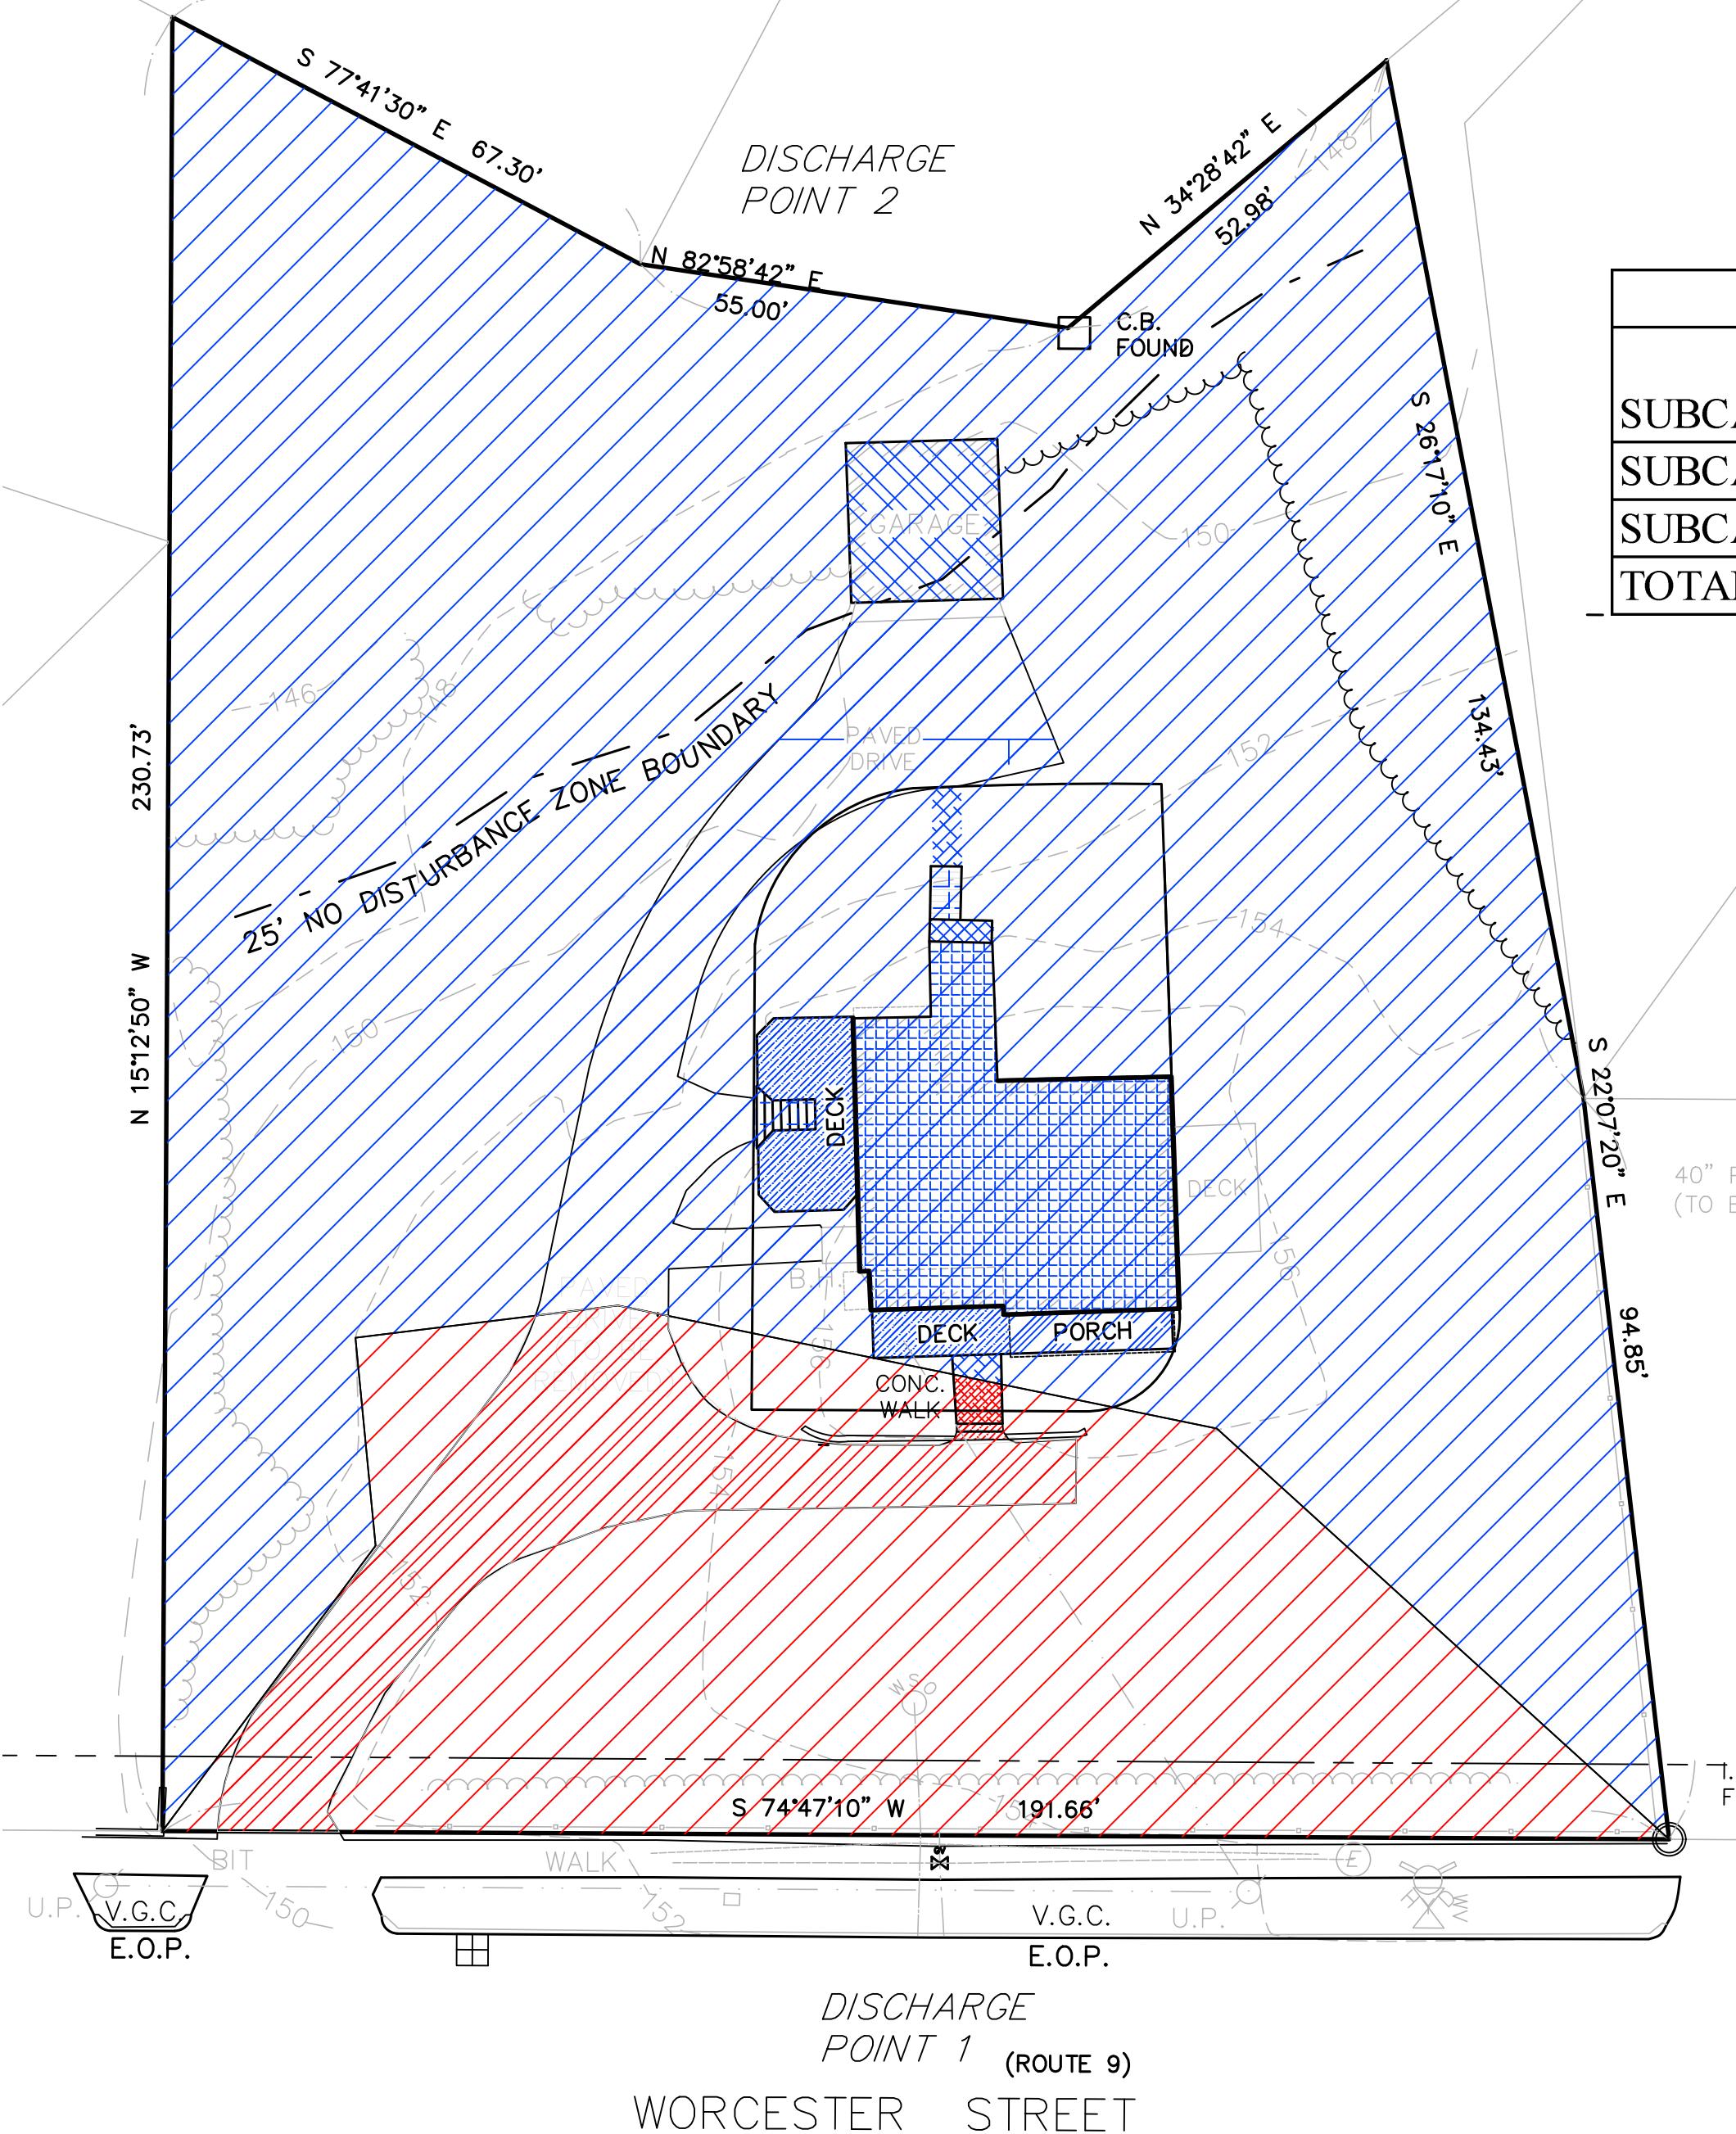

ROUTE 9 (ROUTE 9)
WORCESTER STREET

WORCESTER STREET


EXISTING SUBCATCHMENT CALCULATIONS						
SUBCATCHMENT	LANDSCAPE	BUILDINGS	DRIVEWAY	GENERAL IMPERVIOUS	GARAGE	TOTAL
SUBCATCHMENT 1	6,719.0	-	1,806.0	46.0	-	8,571.0
SUBCATCHMENT 2	23,871.00	1,401.0	1,697.0	657.0	392.1	28,018.1
TOTAL	30,590.0	1,401.0	3,503.0	703.0	392.1	36,589.1

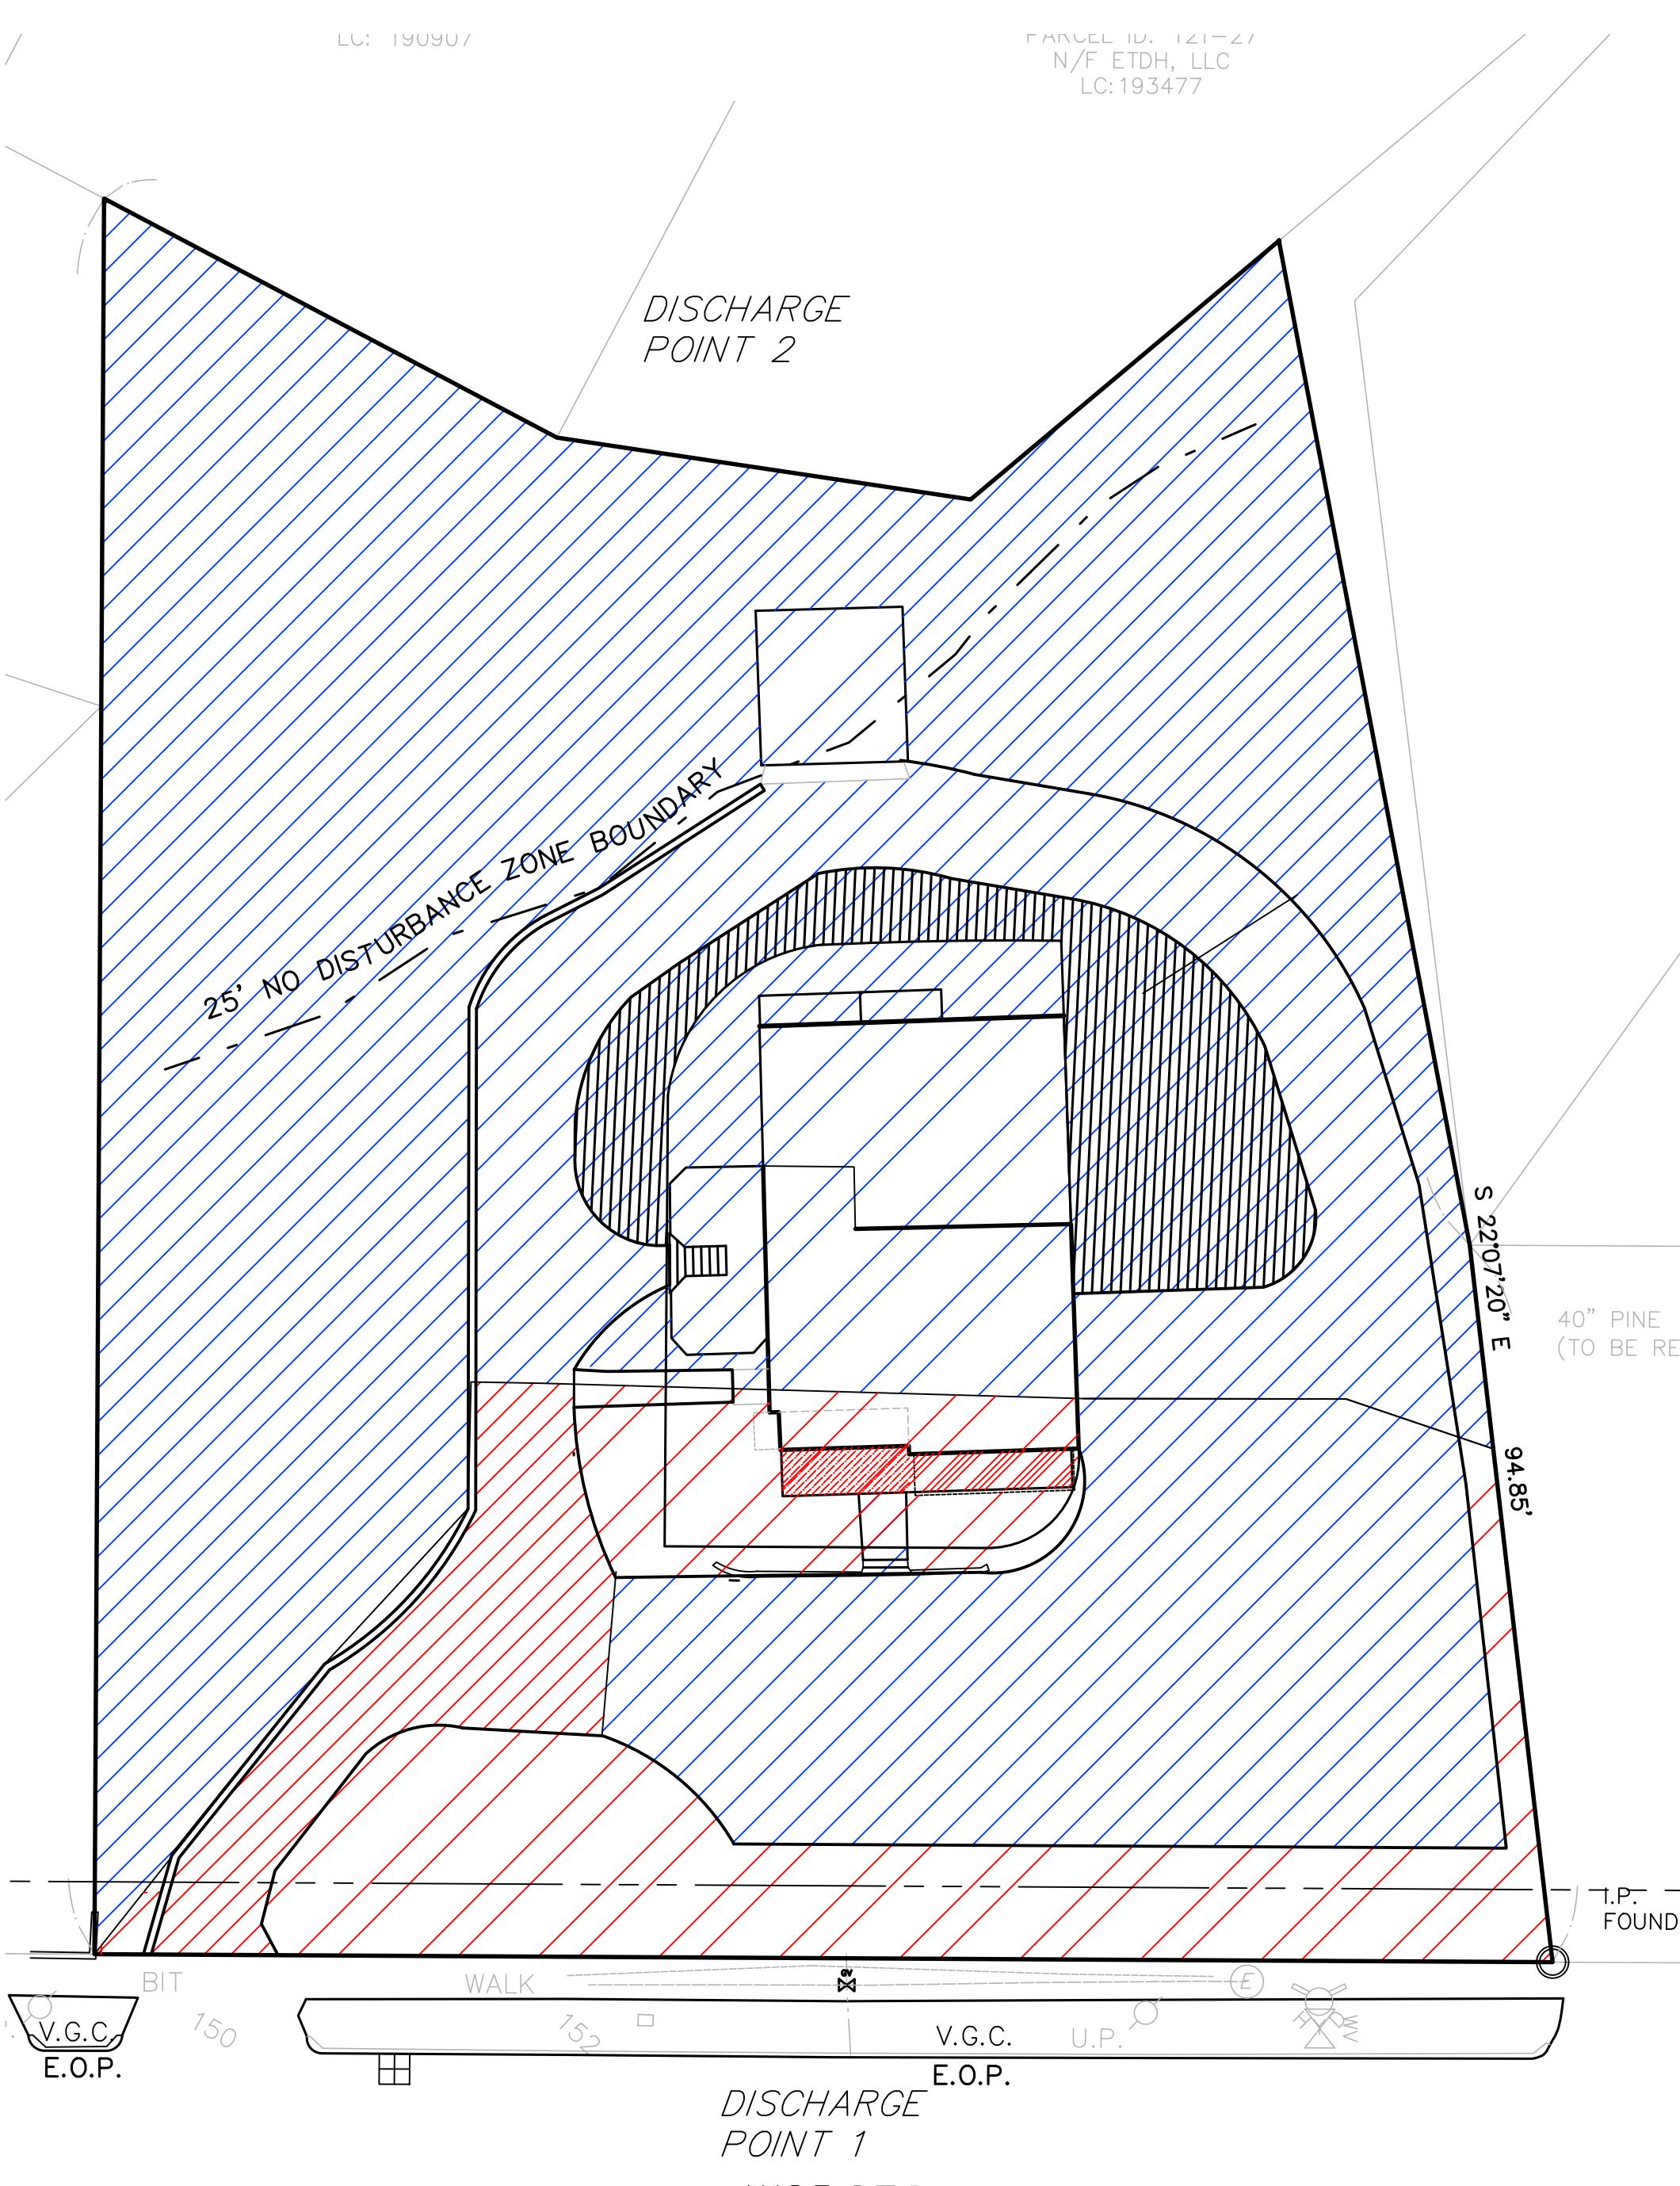

DISCHARGE
POINT 1
WORCESTER STREET

PROPOSED SUBCATCHMENT CALCULATIONS						
SUBCATCHMENT	LANDSCAPE	BUILDINGS	DRIVEWAY	GENERAL IMPERVIOUS	GARAGE	TOTAL
SUBCATCHMENT 1	4,444.0	290.0	1,472.0	209.0	-	6,415.00
SUBCATCHMENT 2	18,220.0	1,972.0	8,917.0	673.0	392.1	30,174.10
TOTAL	22,664.0	2,262.0	10,389.0	882.0	392.1	36,589.10

Discharge points summary table (HydroCAD results)					
DISCHARGE POINT	STORM EVENT	RUNOFF RATE		VOLUME OF RUNOFF	
		EXISTING	PROPOSED	EXISTING	PROPOSED
#1	100-Year	0.92	0.18	2,768.0	668.0
#2	100-Year	2.60	1.37	7,934.0	4,426.0

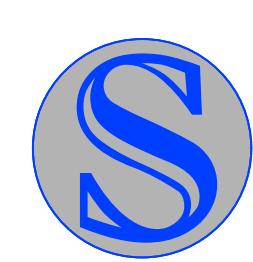

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679 WORCESTER
STREET, WELLESLEY
MASSACHUSETTS

CIVIL PLAN

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DATE:	11/5/2025
DRAWN BY:	Y.L.
CHECKED BY:	G.B.
APPROVED BY:	E.S

WATERSHED MAP

SHEET C20



EROSION CONTROL NOTES

1. THE EROSION CONTROL PLANS IN THIS SET SHALL BE REVIEWED AND IMPLEMENTED BY THE CONTRACTOR PRIOR TO COMMENCEMENT OF WORK. CONTRACTOR SHALL WORK WITH THE PROJECT'S ENGINEER THROUGHOUT CONSTRUCTION TO ENSURE THE SITE IS PROPERLY PROTECTED FROM POSSIBLE POLLUTANTS. THE ENGINEER HAS AUTHORIZATION TO ADD OR REMOVE BMP MEASURES THROUGHOUT CONSTRUCTION.
2. THE CONTRACTOR SHALL BE RESPONSIBLE FOR IMPLEMENTING AND MAINTAINING SITE EROSION CONTROL AT ALL TIMES.
3. IT SHALL BE THE RESPONSIBILITY OF THE OWNER AND THE PERMITTEE TO ENSURE THAT EROSION DOES NOT OCCUR FROM ANY ACTIVITY DURING OR AFTER PROJECT CONSTRUCTION. ADDITIONAL MEASURES, BEYOND THOSE SPECIFIED, MAY BE REQUIRED BY THE PLANNING DIRECTOR AS DEEMED NECESSARY TO CONTROL ACCELERATED EROSION.
4. AT THE END OF EACH WORKDAY, AT THE END OF EACH WORKWEEK, THE CONTRACTOR SHALL IMPLEMENT ALL TEMPORARY MEASURES NECESSARY TO PREVENT EROSION AND SILTATION, UNTIL THE PROJECT HAS BEEN FINALIZED. THESE MEASURES SHALL INCLUDE, BUT NOT BE LIMITED TO, DIRECT SEEDING OF THE AFFECTED AREAS, STRAW MULCHING, AND/OR INSTALLATION OF STRAW BALES DAMS/SILT FENCES.
5. DURING CONSTRUCTION, NO TURBID WATER SHALL BE PERMITTED TO LEAVE THE SITE. USE OF SILT AND GREASE TRAPS, FILTER BERMS, HAY BALES OR SILT FENCES SHALL BE USED TO PREVENT SUCH DISCHARGE.
6. ALL AREAS ON- AND OFF-SITE EXPOSED DURING CONSTRUCTION ACTIVITIES, IF NOT PERMANENTLY LANDSCAPED PER PLAN, SHALL BE PROTECTED BY MULCHING AND/OR SEEDING.
7. ALL EXCAVATED MATERIAL SHALL BE REMOVED TO AN APPROVED DISPOSAL SITE OR DISPOSED OF ON-SITE IN A MANNER THAT WILL NOT CAUSE EROSION.
8. ANY MATERIAL STOCKPILED, FOR LONGER THAN 14 DAYS, DURING CONSTRUCTION SHALL BE COVERED WITH PLASTIC.
9. UPON COMPLETION OF CONSTRUCTION, ALL REMAINING EXPOSED SOILS SHALL BE PERMANENTLY REVEGETATED.
10. IT IS THE CONTRACTOR'S RESPONSIBILITY TO SEE THAT ADDITIONAL MEASURES NECESSARY TO CONTROL SITE EROSION AND PREVENT SEDIMENT TRANSPORT OFF-SITE ARE IMPLEMENTED.
11. ALL SPILLS AND/OR LEAKS SHALL BE IMMEDIATELY CLEANED UP AND MITIGATED.

CONSTRUCTION MATERIALS

- ALL LOOSE STOCKPILED CONSTRUCTION MATERIALS THAT ARE NOT ACTIVELY BEING USED (I.E. SOIL, SPOILS, AGGREGATE, FLY-ASH, STUCCO, HYDRATED LIME, ETC.) SHALL BE COVERED AND BERMED.
- ALL CHEMICALS SHALL BE STORED IN WATERTIGHT CONTAINERS (WITH APPROPRIATE SECONDARY CONTAINMENT TO PREVENT ANY SPILLAGE OR LEAKAGE) OR IN A STORAGE SHED (COMPLETELY ENCLOSED).
- EXPOSURE OF CONSTRUCTION MATERIALS TO PRECIPITATION SHALL BE MINIMIZED. THIS DOES NOT INCLUDE MATERIALS AND EQUIPMENT THAT ARE DESIGNED TO BE OUTDOORS AND EXPOSED TO ENVIRONMENTAL CONDITIONS (I.E. POLES, EQUIPMENT PADS, CABINETS, CONDUCTORS, INSULATORS, BRICKS, ETC.).
- BEST MANAGEMENT PRACTICES TO PREVENT THE OFF-SITE TRACKING OF LOOSE CONSTRUCTION AND LANDSCAPE MATERIALS SHALL BE IMPLEMENTED.

WASTE MANAGEMENT

- DISPOSAL OF ANY RINSE OR WASH WATERS OR MATERIALS ON IMPERVIOUS OR PERVIOUS SITE SURFACES OR INTO THE STORM DRAIN SYSTEM SHALL BE PREVENTED.
- SANITATION FACILITIES SHALL BE CONTAINED (E.G. PORTABLE TOILETS) TO PREVENT DISCHARGES OF POLLUTANTS TO THE STORM WATER DRAINAGE SYSTEM OR RECEIVING WATER, AND SHALL BE LOCATED A MINIMUM 20 FEET AWAY FROM AN INLET, STREET OR DRIVEWAY, STREAM, RIPARIAN AREA OR OTHER DRAINAGE FACILITY.
- SANITATION FACILITIES SHALL BE INSPECTED REGULARLY FOR LEAKS AND SPILLS AND CLEANED OR REPLACED AS NECESSARY.
- COVER WASTE DISPOSAL CONTAINERS AT THE END OF EVERY BUSINESS DAY AND DURING A RAIN EVENT.
- DISCHARGES FROM WASTE DISPOSAL CONTAINERS TO THE STORM WATER DRAINAGE SYSTEM OR RECEIVING WATER SHALL BE PREVENTED.
- STOCKPILED WASTE MATERIAL SHALL BE CONTAINED AND SECURELY PROTECTED FROM WIND AND RAIN AT ALL TIMES UNLESS ACTIVELY BEING USED.

VEHICLE STORAGE AND MAINTENANCE

- MEASURES SHALL BE TAKEN TO PREVENT OIL, GREASE, OR FUEL TO LEAK IN TO THE GROUND, STORM DRAINS OR SURFACE WATERS.
- ALL EQUIPMENT OR VEHICLES, WHICH ARE TO BE FUELED, MAINTAINED AND STORED ONSITE SHALL BE IN A DESIGNATED AREA FITTED WITH APPROPRIATE BMPs.
- LEAKS SHALL BE IMMEDIATELY CLEANED AND LEAKED MATERIALS SHALL BE DISPOSED OF PROPERLY.

LANDSCAPE MATERIALS

- CONTAIN STOCKPILED MATERIALS SUCH AS MULCHES AND TOPSOIL WHEN THEY ARE NOT ACTIVELY BEING USED
- CONTAIN FERTILIZERS AND OTHER LANDSCAPE MATERIALS WHEN THEY ARE NOT ACTIVELY BEING USED.
- DISCONTINUE THE APPLICATION OF ANY ERODIBLE LANDSCAPE MATERIAL WITHIN 2 DAYS BEFORE A FORECASTED RAIN EVENT OR DURING PERIODS OF PRECIPITATION.
- APPLY ERODIBLE LANDSCAPE MATERIAL AT QUANTITIES AND APPLICATION RATES ACCORDING TO MANUFACTURE RECOMMENDATIONS OR BASED ON WRITTEN SPECIFICATIONS BY KNOWLEDGEABLE AND EXPERIENCED FIELD PERSONNEL.
- STACK ERODIBLE LANDSCAPE MATERIAL ON PALLETS AND COVERING OR

INSPECTION AND MAINTENANCE:

1. FILTER FABRIC BARRIERS SHALL BE INSPECTED WEEKLY AFTER EACH SIGNIFICANT STORM - 1 INCH RAINFALL (25.4 MM) IN 24 HOUR PERIOD. ANY REQUIRED REPAIRS SHALL BE MADE IMMEDIATELY.
2. SEDIMENT SHOULD BE REMOVED WHEN IT REACHES 0.5" MAXIMUM HEIGHT. AT THAT TIME INSPECT THE FILTER MATERIAL FOR TEARS AND CLEAN OR REPLACE AS REQUIRED.
3. THE REMOVED SEDIMENT SHALL BE DISTRIBUTED EVENLY ACROSS AREAS ON-SITE, CONFORM WITH THE EXISTING GRADE AND BE REVEGETATED OR OTHERWISE STABILIZED PER EROSION CONTROL NOTES.

8. INSPECT THE STRAW WATTLE AND THE SLOPES AFTER SIGNIFICANT STORMS. MAKE SURE THE WATTERS ARE IN CONTACT WITH THE SOIL.
9. REPAIR ANY RILLS OR GULLIES PROMPTLY.
10. RESEED OR REPLANT VEGETATION IF NECESSARY UNTIL THE



SPRUELLIAN

SPRUHAN
ENGINEERING,

80 JEWETT ST, (SUITE
NEWTON, MA 02458

Tel: 617-816-0722

679 WORCESTER
STREET, WELLESLEY


11. *What is the name of the author?*



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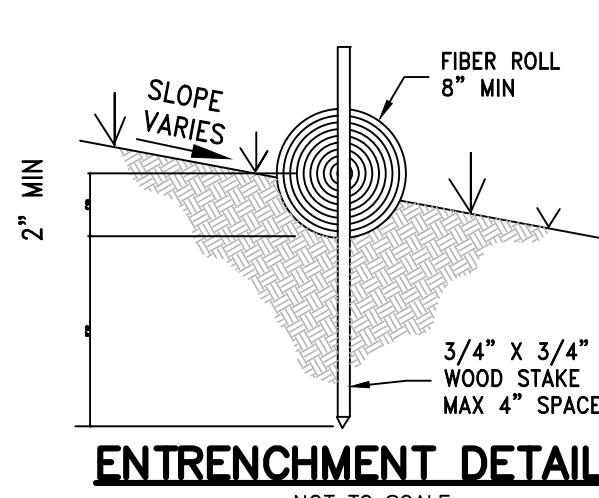
DATE:	9/24/2025
DRAWN BY:	Y.L.
CHECKED BY:	G.B.
APPROVED BY:	E.S

SHEET C4.C




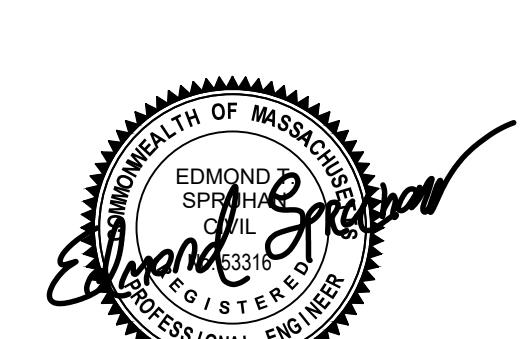

TYPICAL INSTALLATION

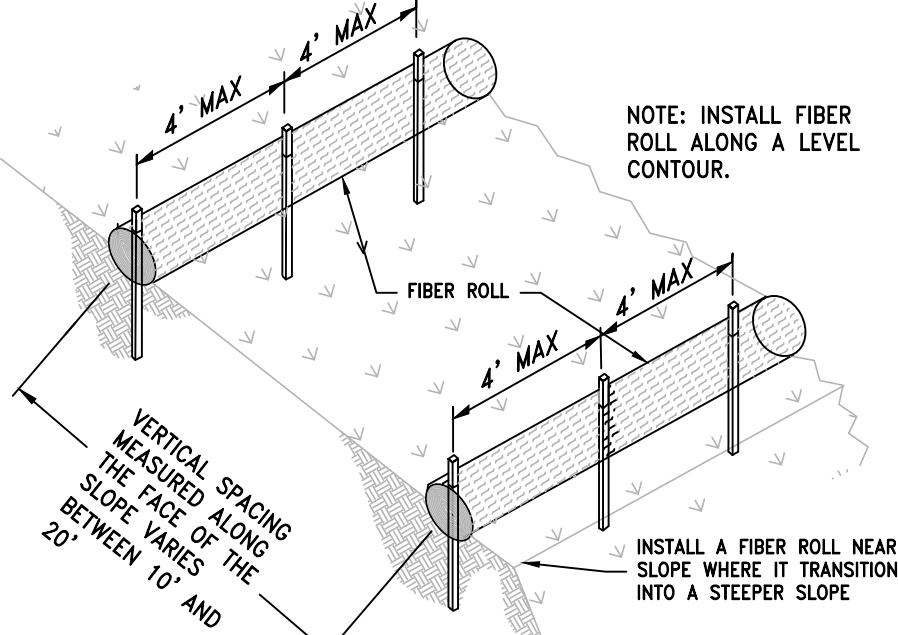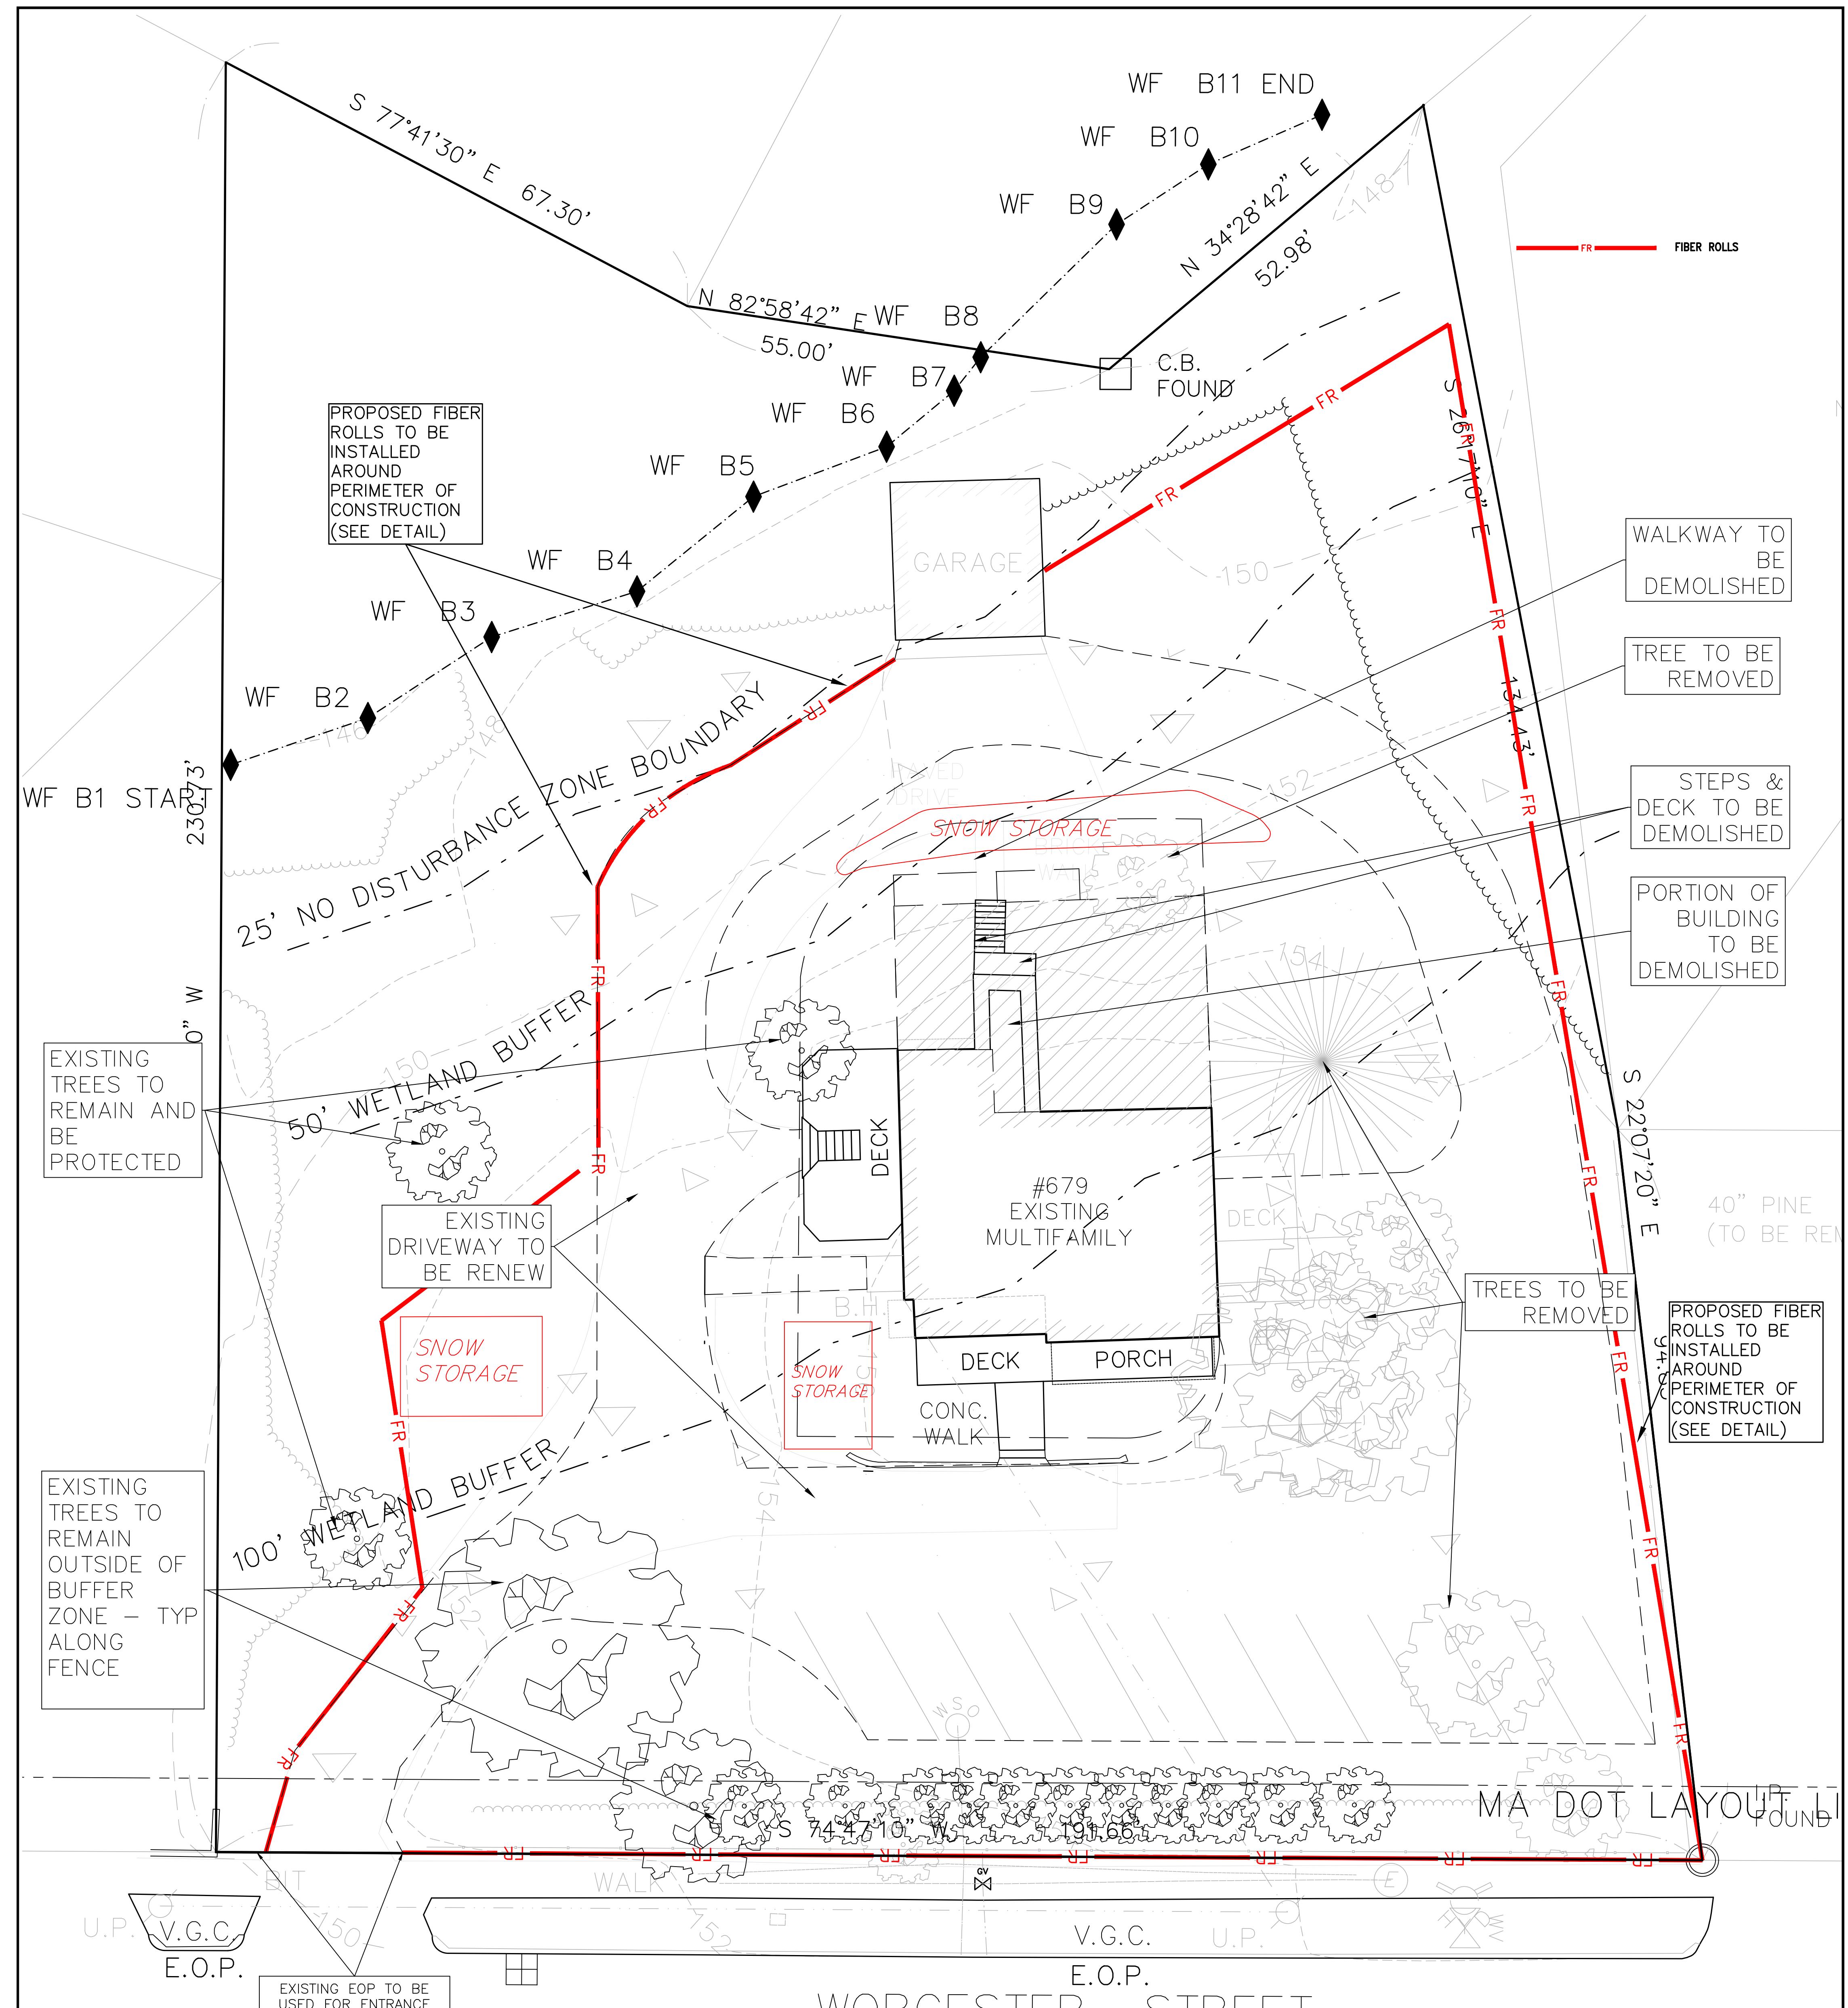

ALL EROSION MITIGATION MEASURES
SHALL BE IN PLACE PRIOR TO MAJOR
CONSTRUCTION OR SOIL DISTURBANCE
COMMENCING ON THE SITE.

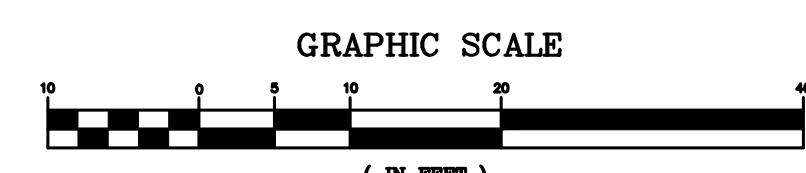

*SPRUHAN
ENGINEERING, P.C.*

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CIVIL PLAN

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DATE:	9/24/2025
DRAWN BY:	Y.L.
CHECKED BY:	G.B.
APPROVED BY:	E.S

SHEET C4.1

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SCOPE OF WORK:

ADDITION, INTERIOR REMODEL, SIDING, ROOFING, EXTERIOR Hardscape.


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- 2: ALL DIMENSIONS TO BE VERIFIED IN FIELD DURING DEMOLITION PHASE.
- 3: THESE DRAWINGS WERE PRODUCED WITH THE INTENTION TO BE USED FOR REMODELWERKS DESIGN/BUILD SYSTEM, AND THEY DO NOT CONTAIN SUFFICIENT DETAILS FOR USE BY OTHER BUILDING/REMODELING COMPANIES. RW AND THE DESIGNER SHALL NOT BE HELD LIABLE OR FINANCIALLY RESPONSIBLE FOR ANY REASON IF OTHER CONTRACTORS PERFORM THE CONSTRUCTION. THESE DRAWINGS MUST BE FIELD VERIFIED FOR ANY AND ALL CONDITIONS, DIMENSIONS, CONFORMITY WITH CODES, ETC.
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DRAWINGS PREPARED BY:



ABLS / VARGAS-IRWIN
679 WORCESTER STREET, WELLESLEY, MA 02482



EXISTING FLOOR PLANS

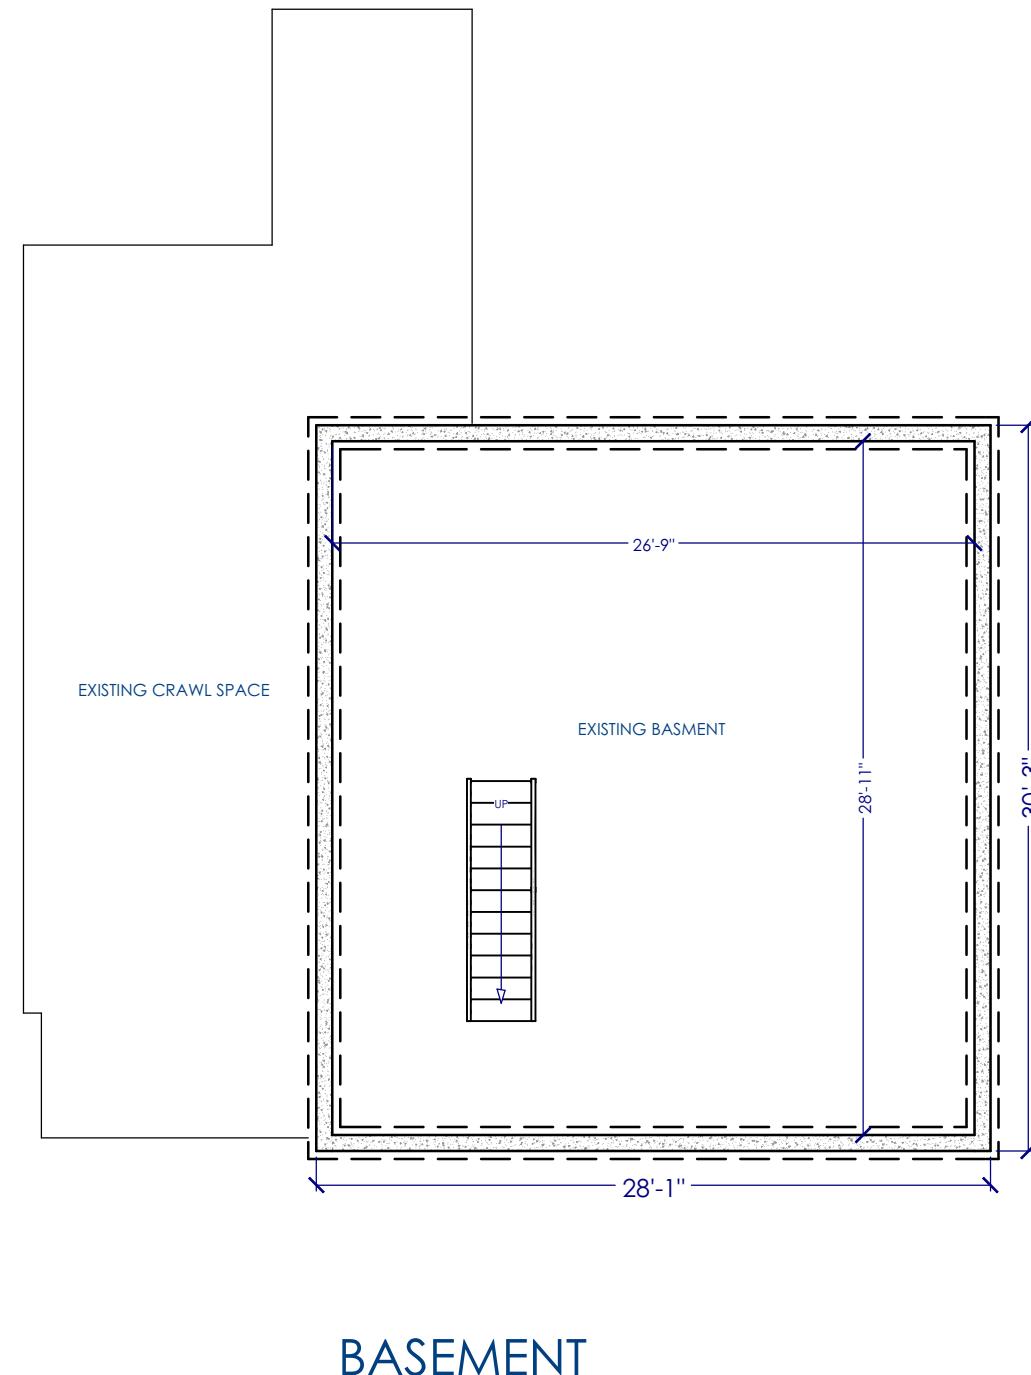1/8" = 1'-0"



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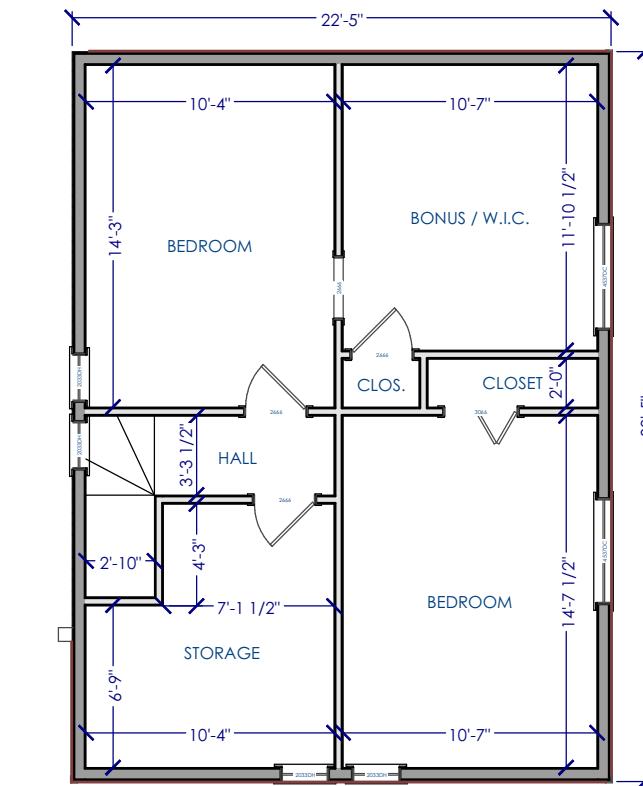
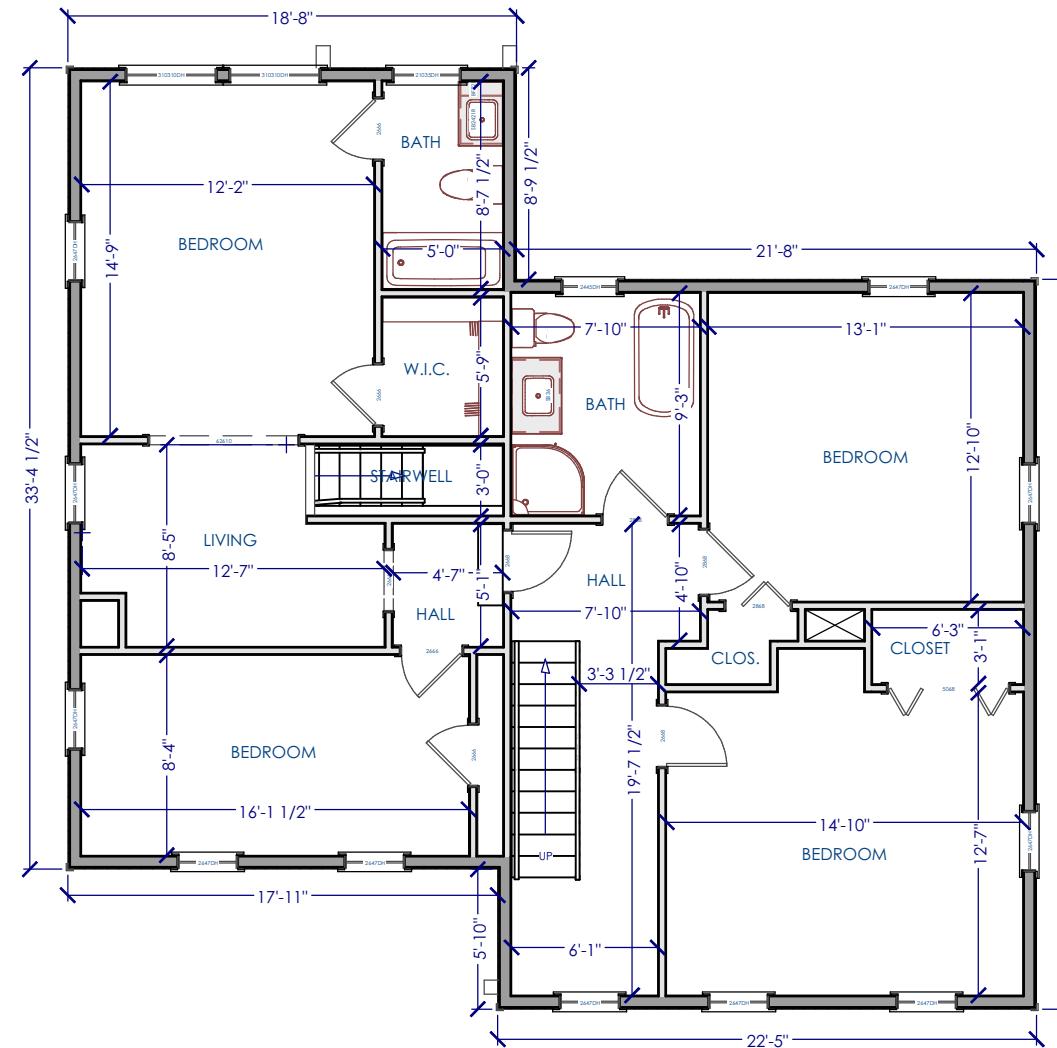
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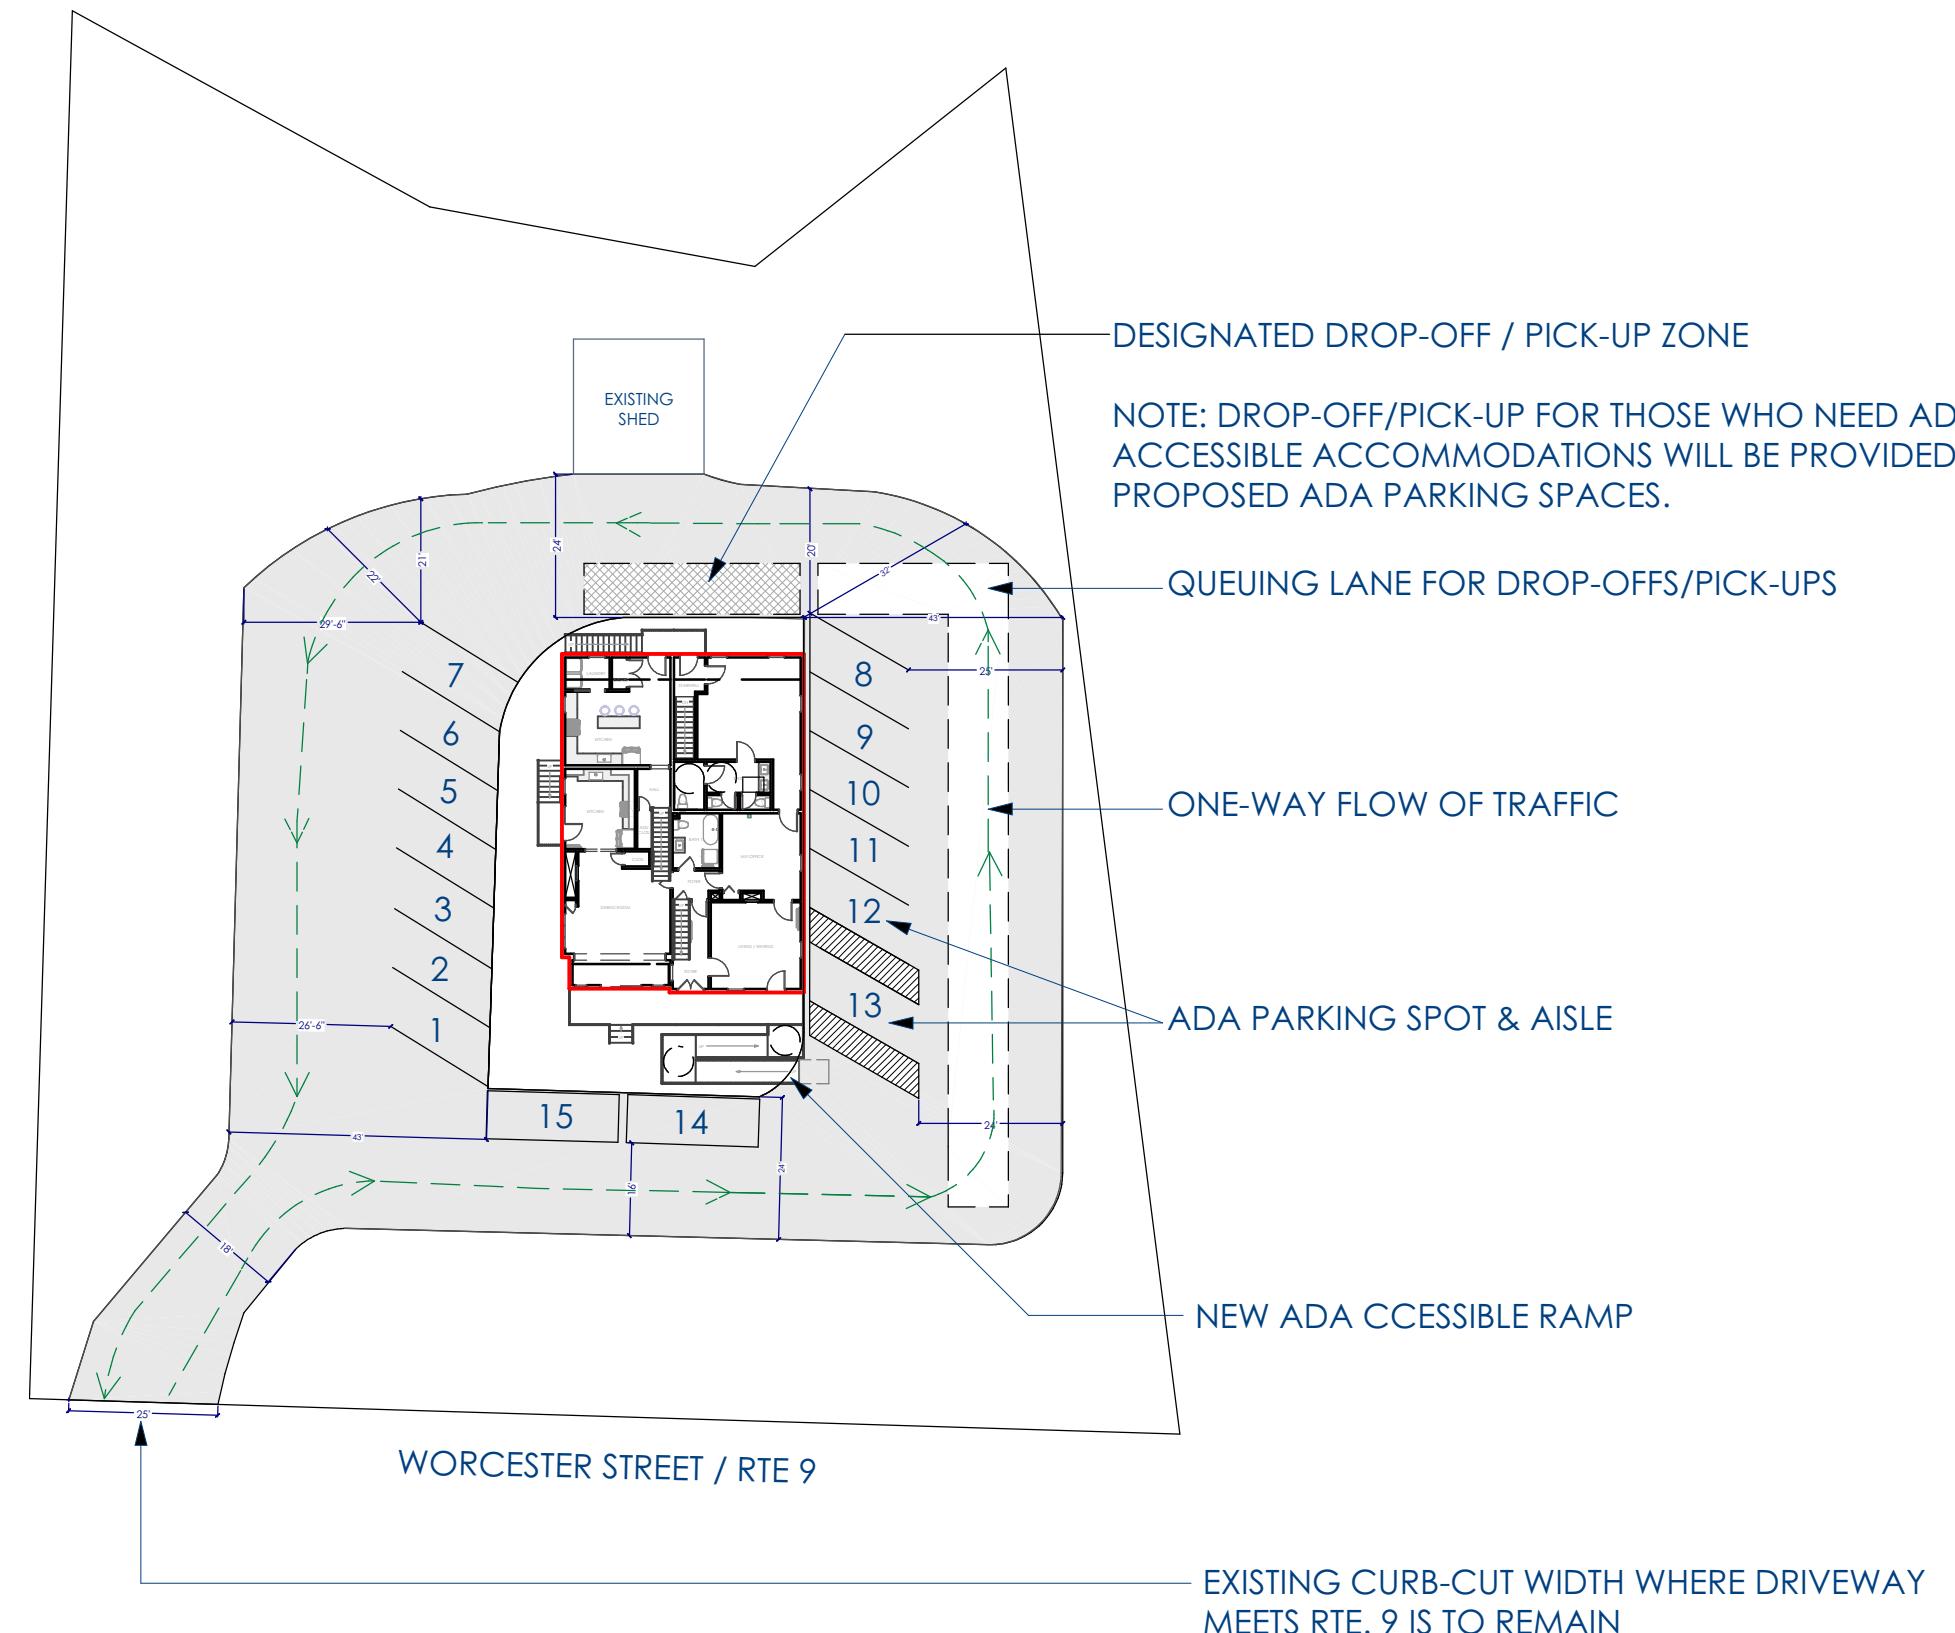
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1	SCHEMATIC	GEF	01.07.25

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A-2



EXISTING FLOOR PLANS
1/8" = 1'-0"



PROPOSED PLOT PLAN
NOT TO SCALE




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SHEET TITLE:
PROPOSED PLOT PLAN

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PROPOSED BASEMENT PLAN

1/8" = 1'-0"



PROJECT DESCRIPTION:
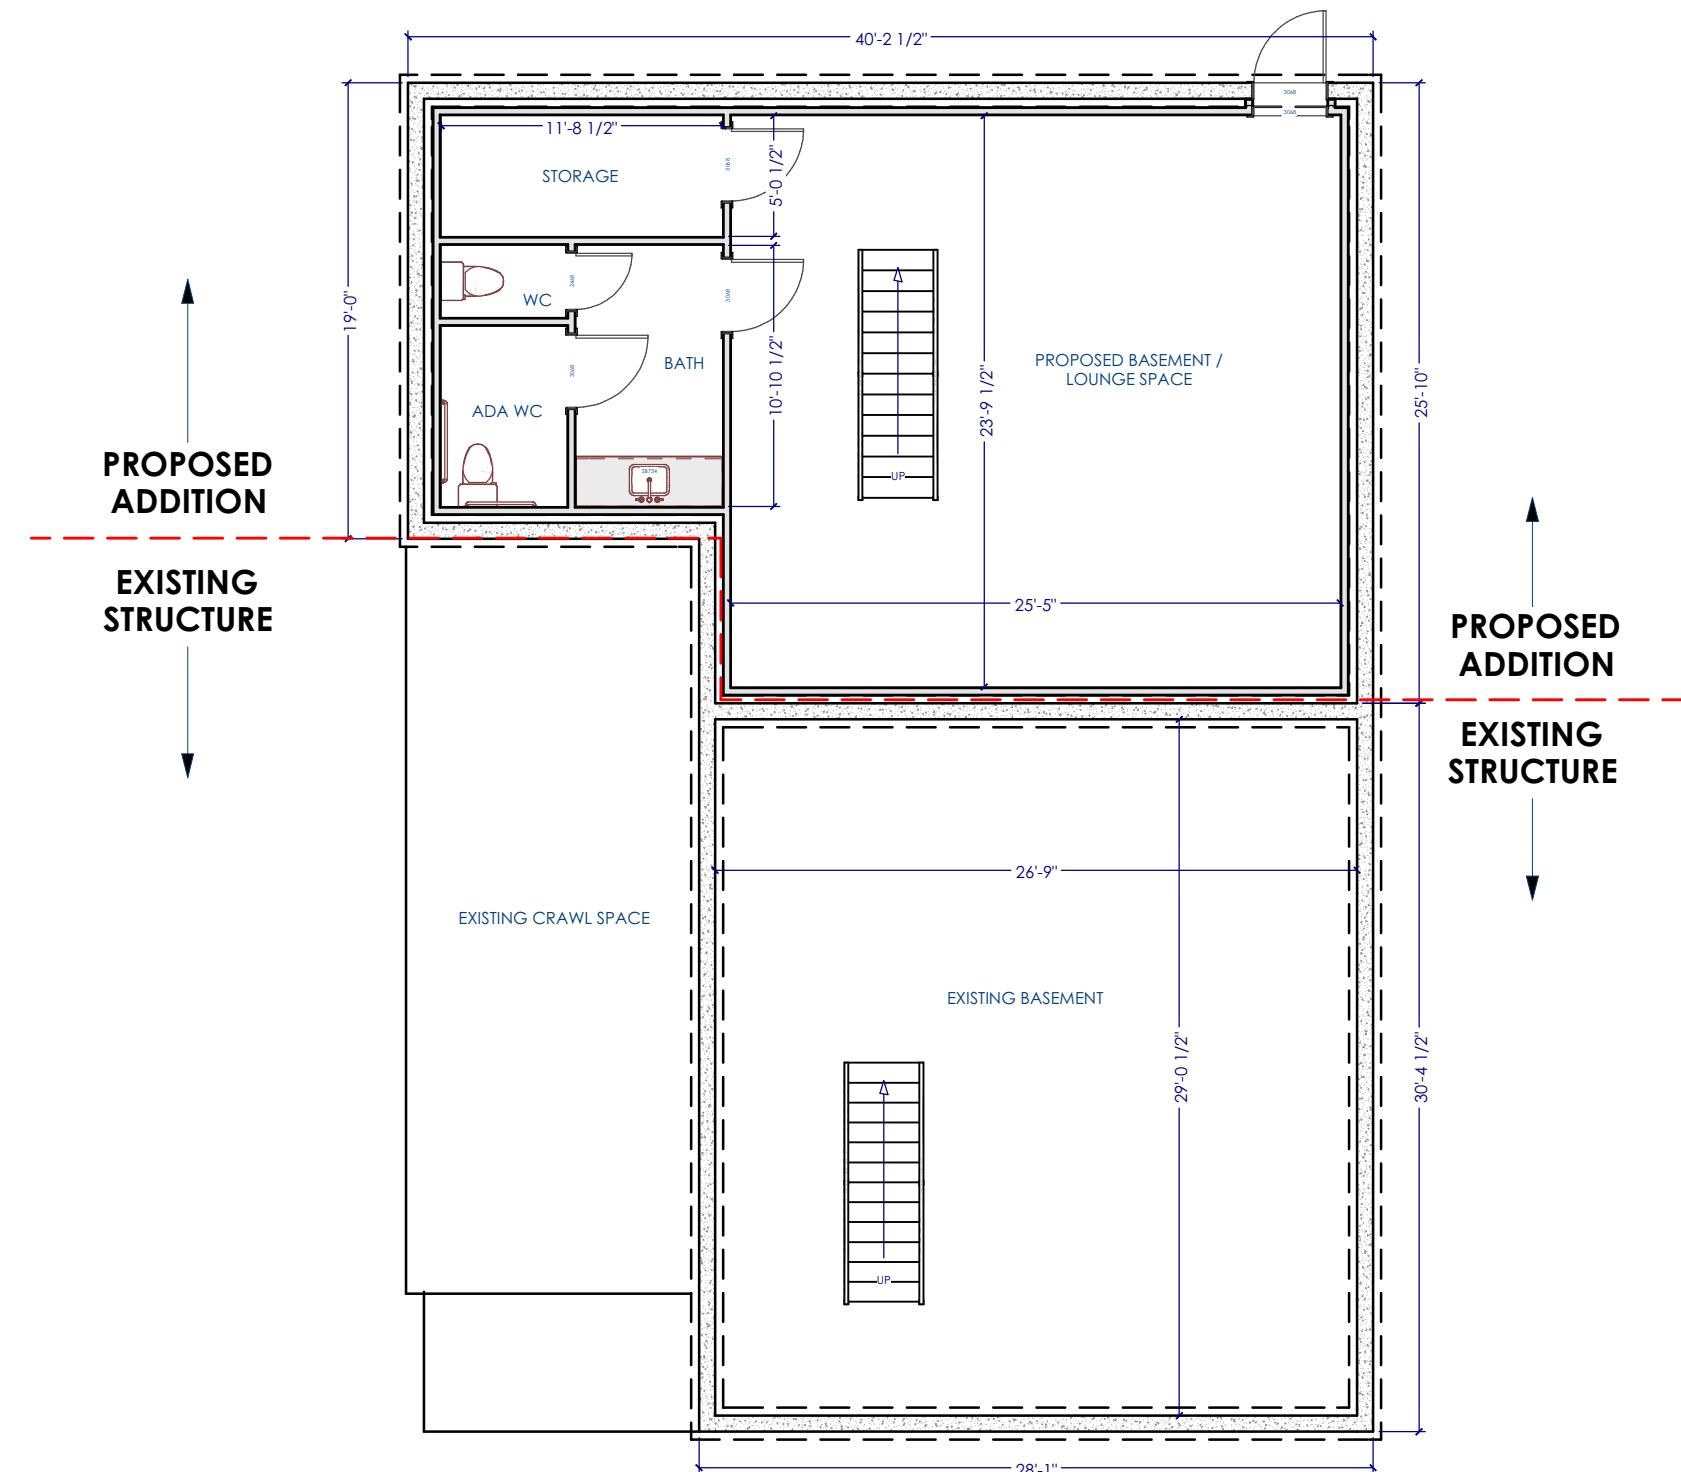
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SHEET TITLE:

PROPOSED BASEMENT
PLAN

NO.

DESCRIPTION

BY

DATE

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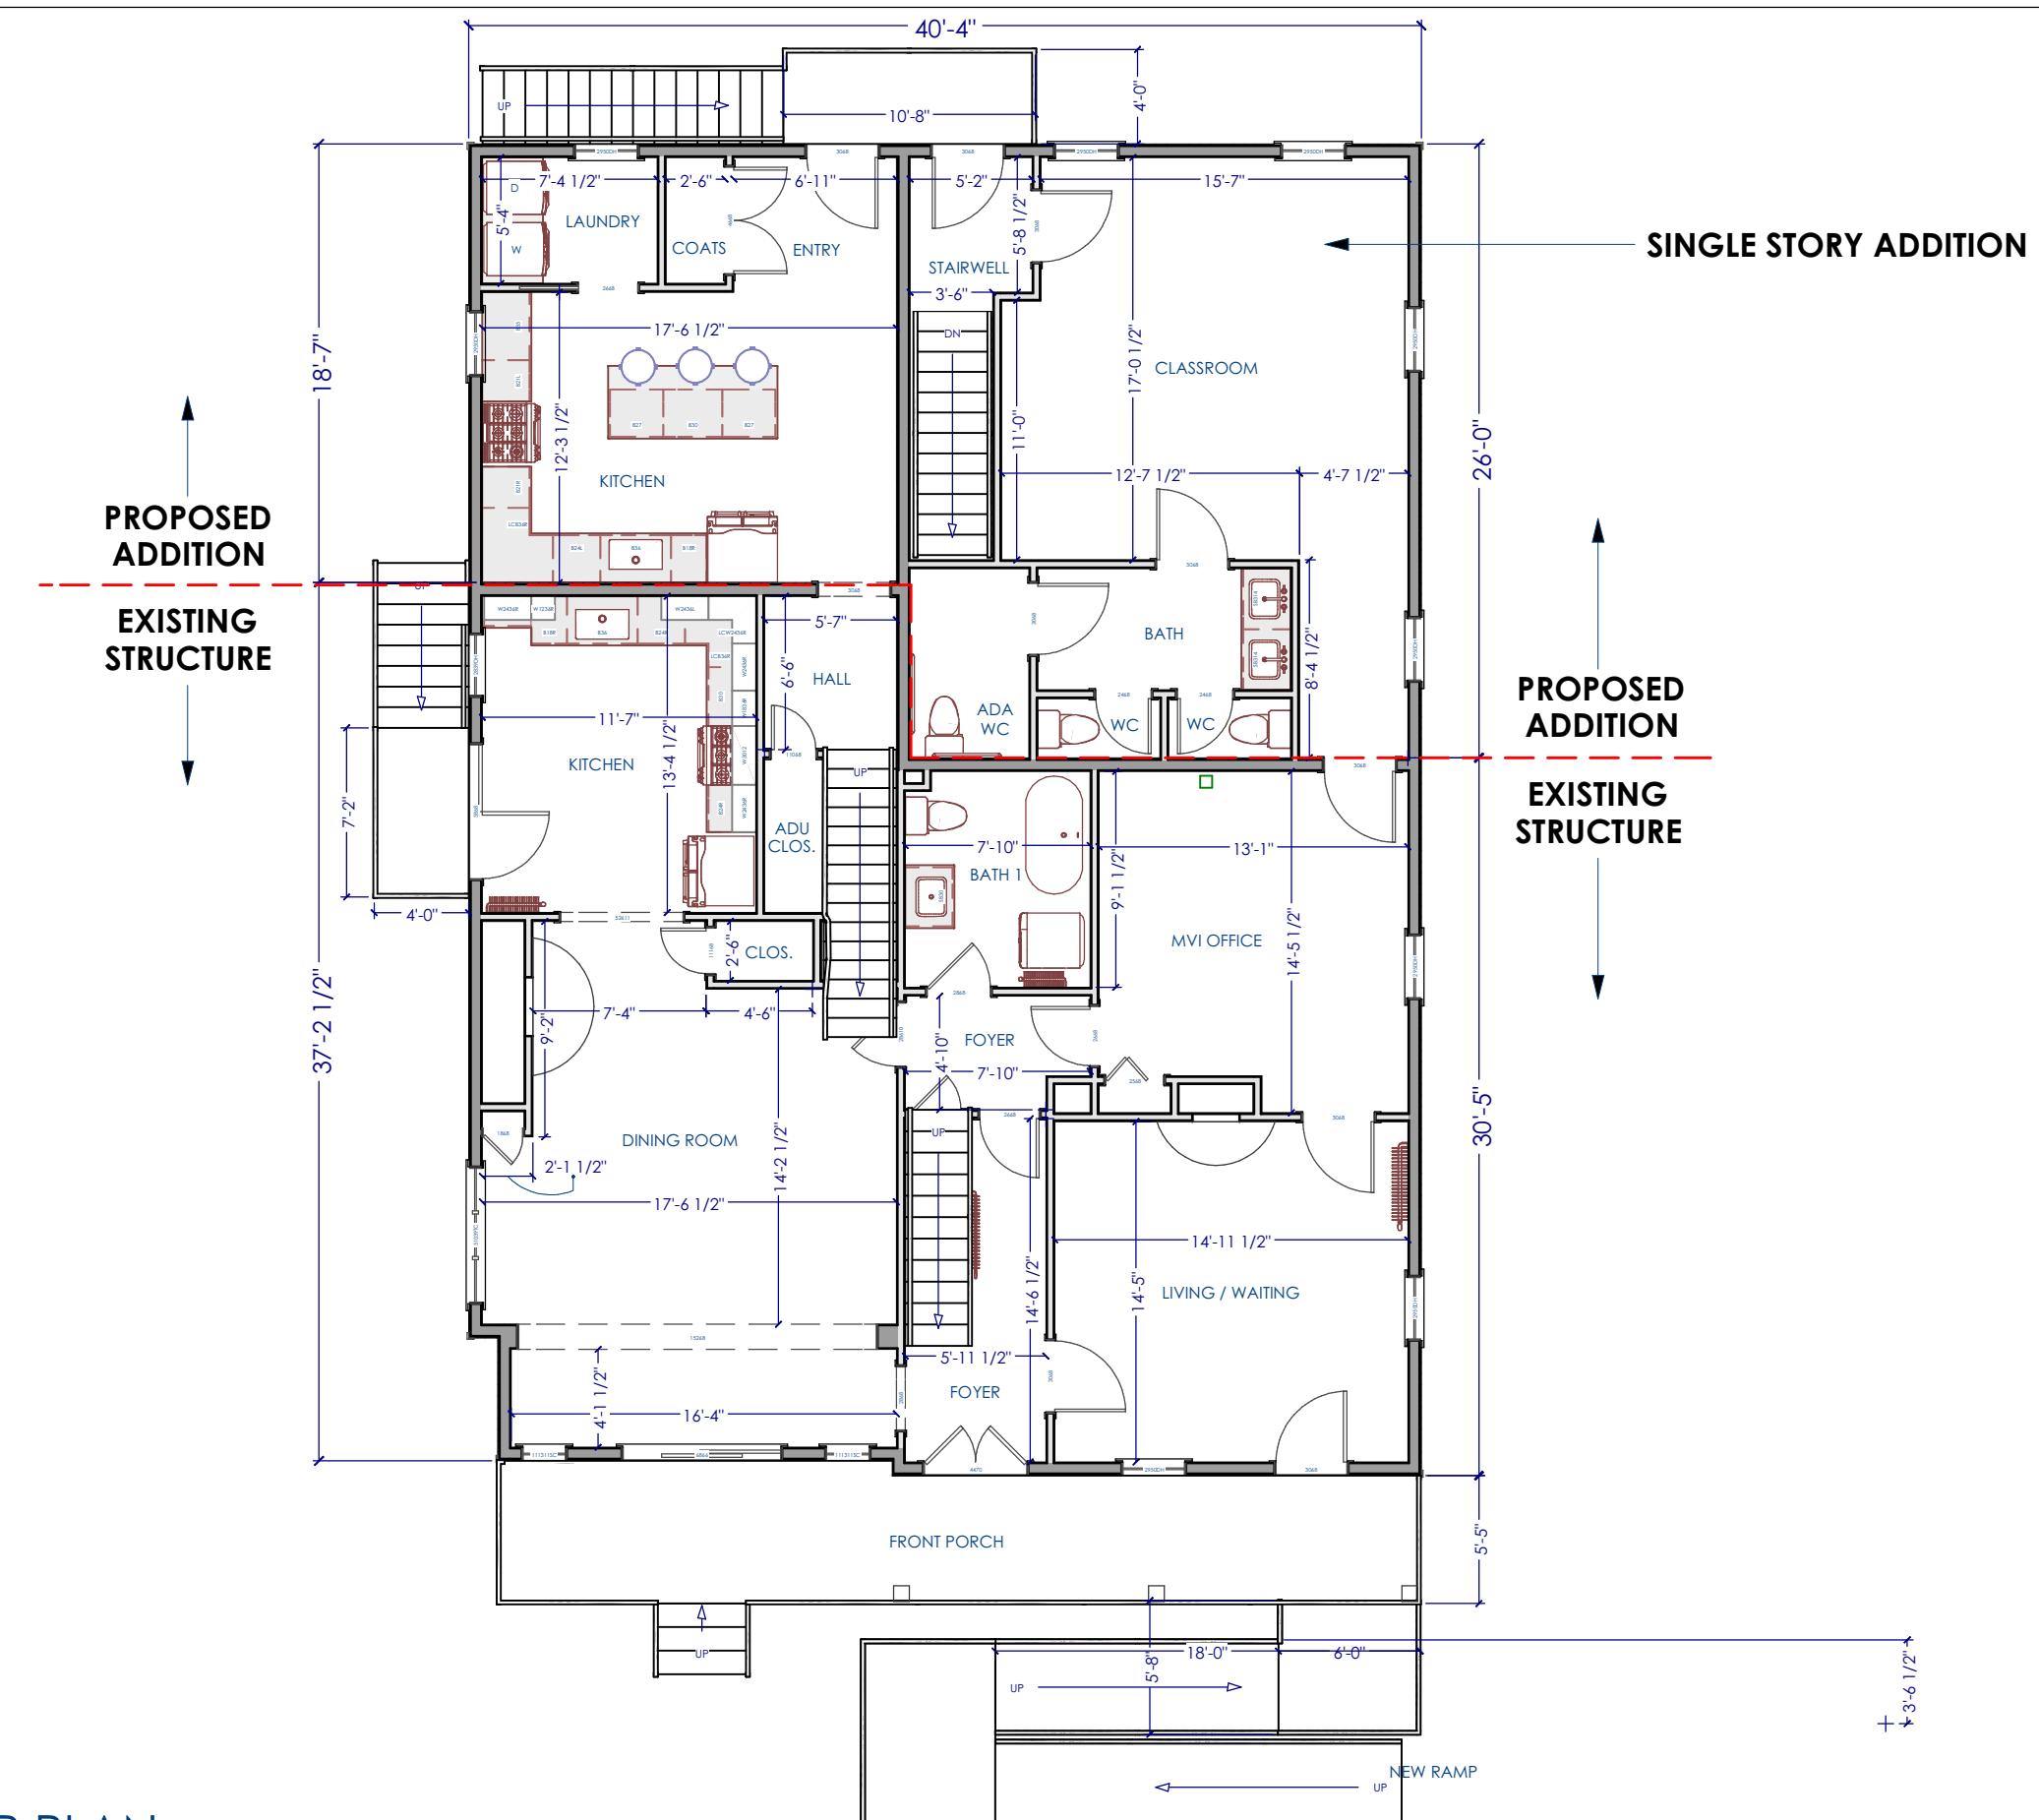
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AS NOTED

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01.07.25

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PROPOSED FIRST FLOOR PLAN

1/8" = 1'-0"





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PROPOSED FIRST
FLOOR PLAN

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PROPOSED SECOND & THIRD FLOOR PLANS

1/8" = 1'-0"



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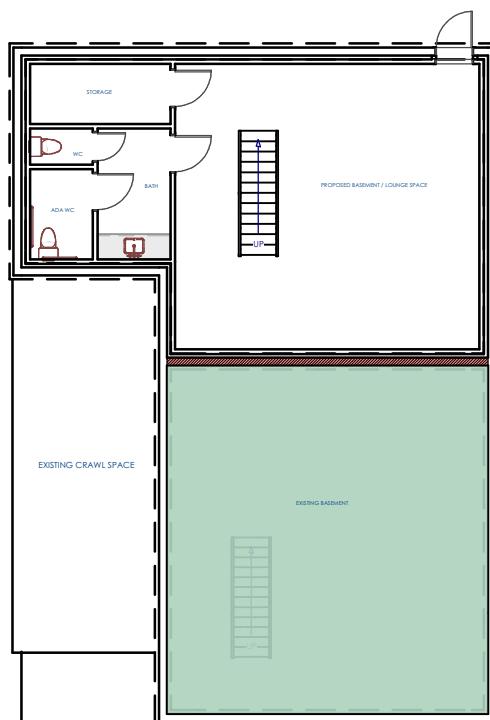
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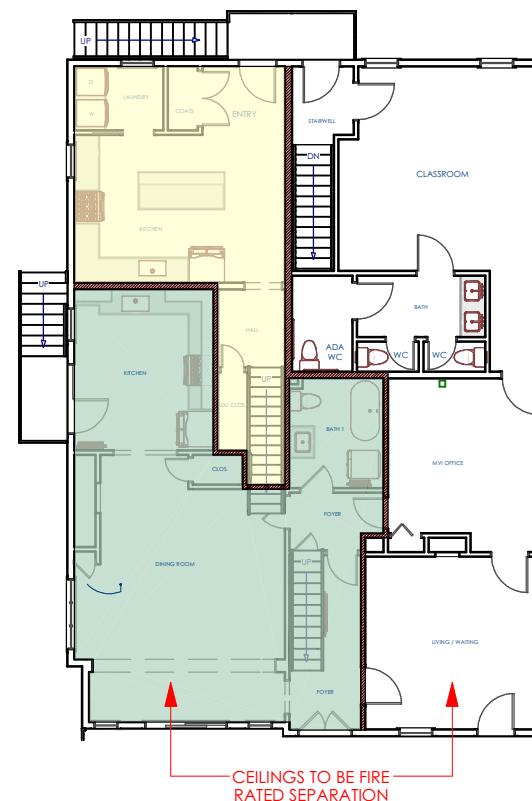
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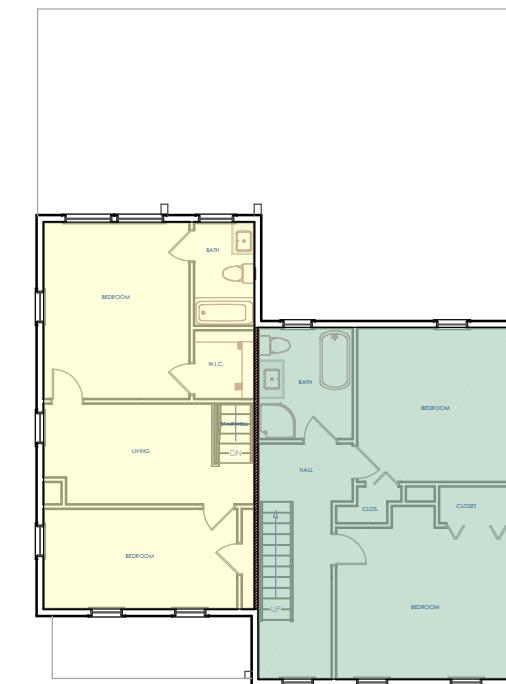
LEGEND	
	ABLS FACILITY
	DWELLING UNIT #1
	DWELLING UNIT #2
	FIRE RATED SEPARATION

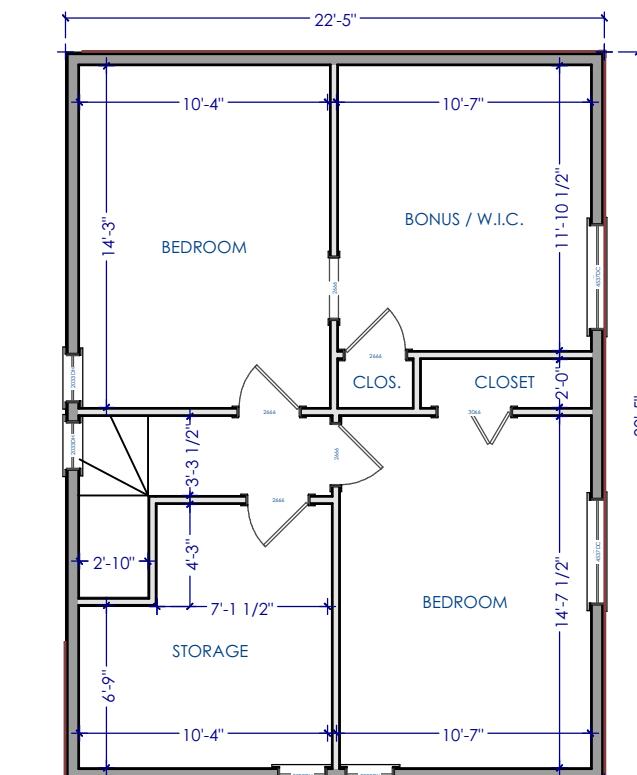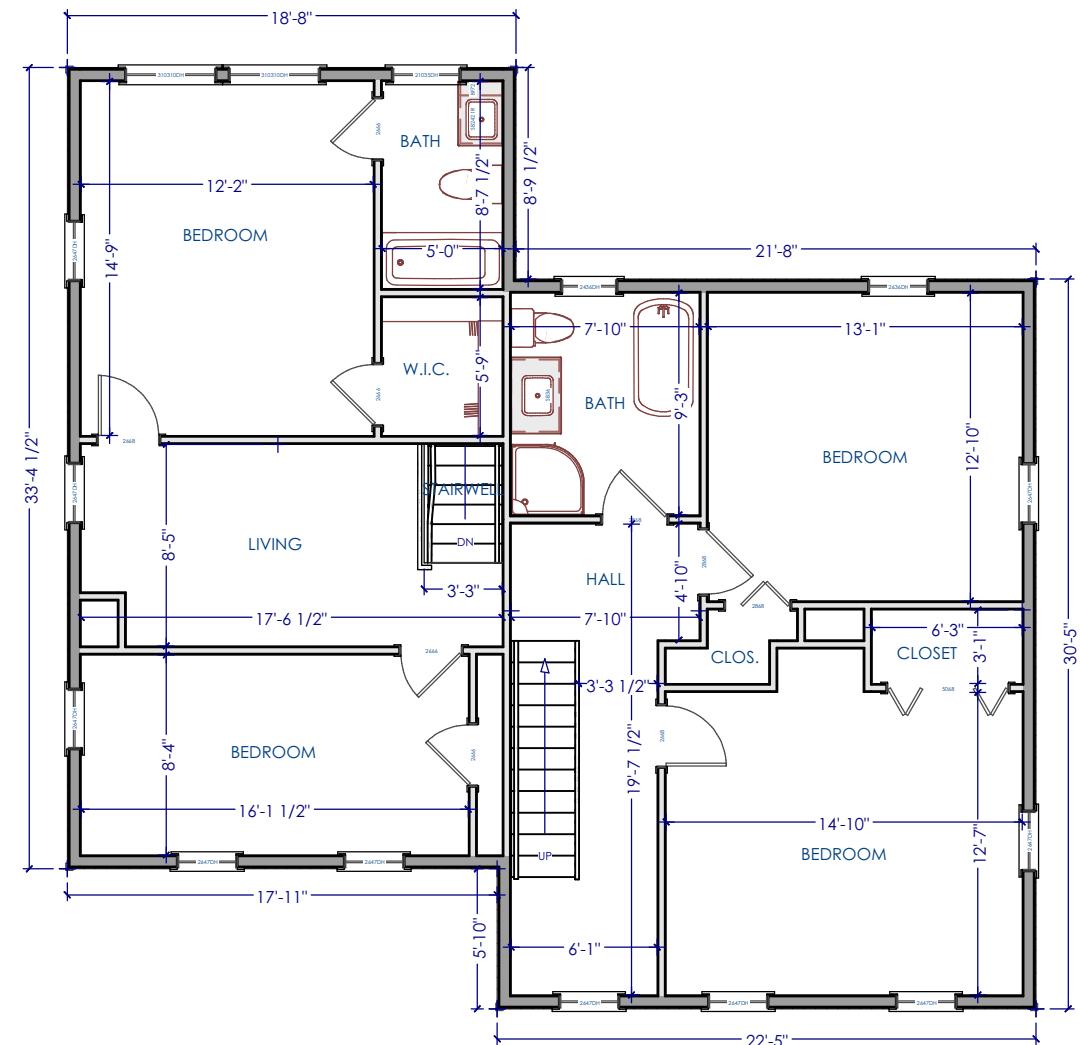


BASMENT



FIRST FLOOR



SECOND FLOOR

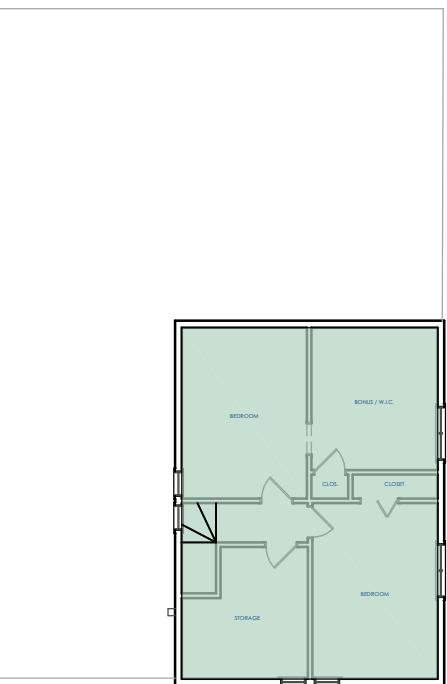


THIRD FLOOR

DIAGRAM - DU #1 VS. DU #2 VS. ABLS
1/8" = 1'-0"



FRONT ELEVATION

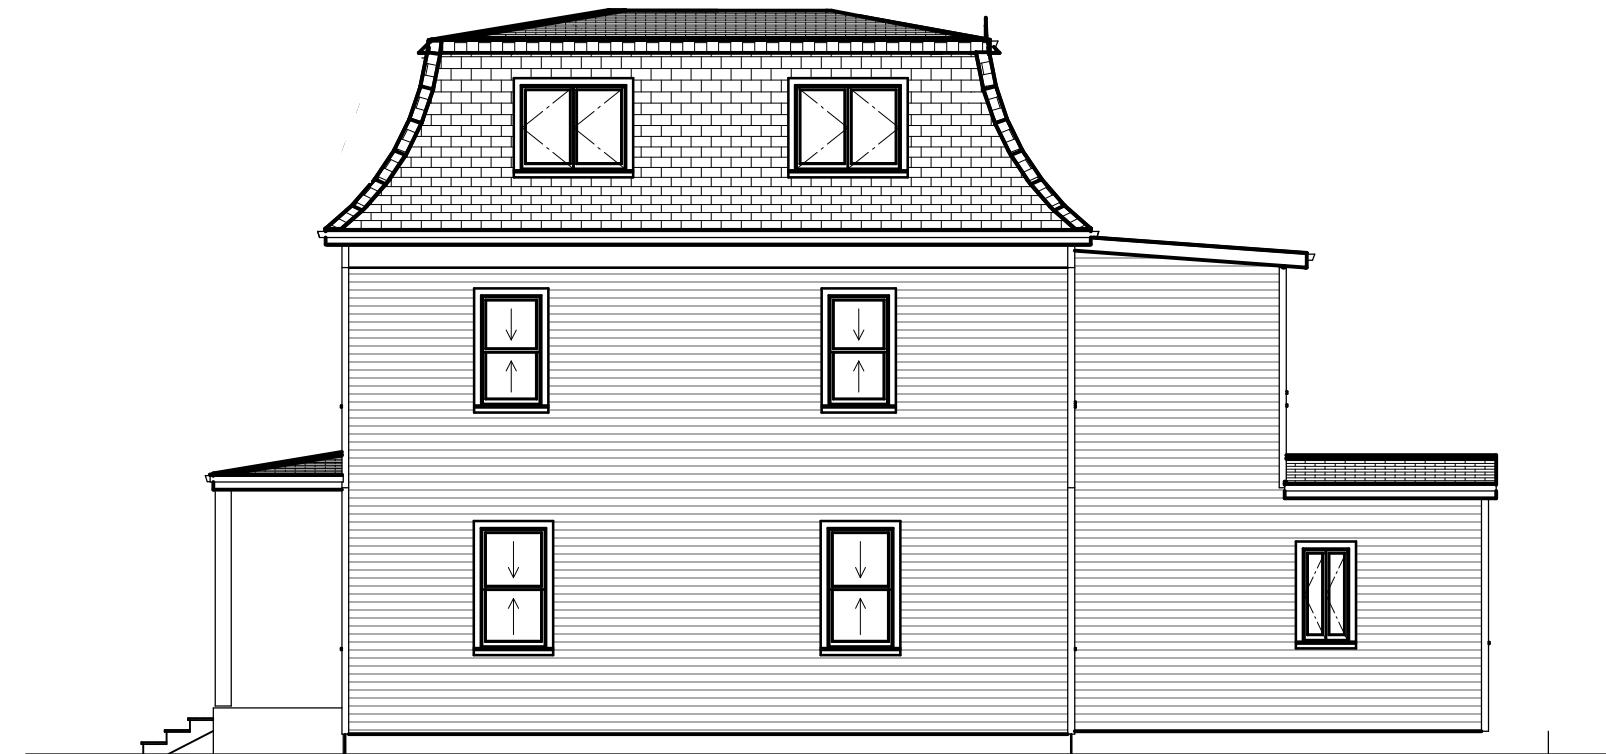

RIGHT ELEVATION

EXISTING EXTERIOR ELEVATIONS

1/8" = 1'-0"



REAR ELEVATION



LEFT ELEVATION

EXISTING EXTERIOR ELEVATIONS

1/8" = 1'-0"



PROJECT DESCRIPTION:

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SHEET TITLE:

EXISTING EXTERIOR
ELEVATIONS

NO.

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PROPOSED EXTERIOR ELEVATIONS - FRONT

1/8" = 1'-0"



PROJECT DESCRIPTION:

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SHEET TITLE:

PROPOSED EXTERIOR
ELEVATIONS

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PROPOSED EXTERIOR ELEVATIONS - RIGHT
1/8" = 1'-0"



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SHEET TITLE:
PROPOSED EXTERIOR
ELEVATIONS

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PROPOSED EXTERIOR ELEVATIONS - REAR

1/8" = 1'-0"



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ELEVATIONS

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A-13



PROPOSED EXTERIOR ELEVATIONS - LEFT

1/8" = 1'-0"



PROJECT DESCRIPTION:

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SHEET TITLE:

PROPOSED EXTERIOR
ELEVATIONS

NO.

1

DESCRIPTION

SCHEMATIC

BY

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